




BID PACKAGE 3 ENCLOSURE/SITE/MEPFP/INTERIOR ADDENDUM #003 PROJECT NO. 655.000

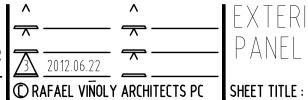


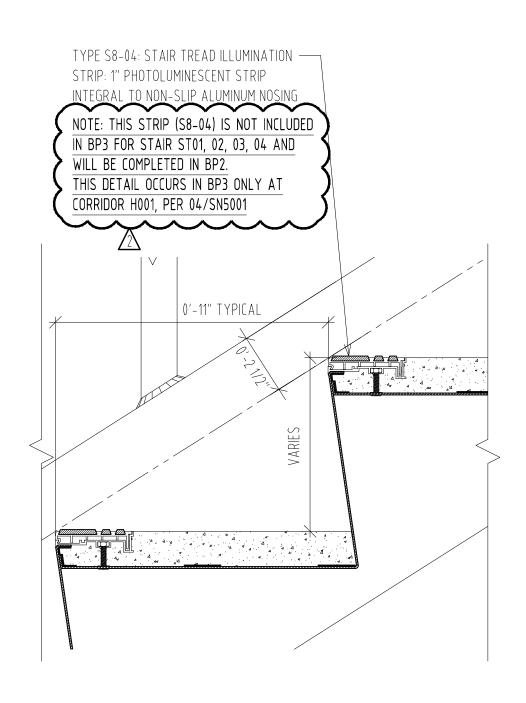

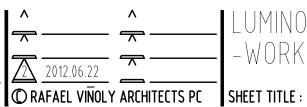

LUMINOUS EGRESS MARKING TYPE S8-04 : STAIR TREAD SECTION DETAIL -WORK SCOPE CLARIFICATION REF. DWG # 10/SN5001

SCALE : 1/2" = 1'-0"

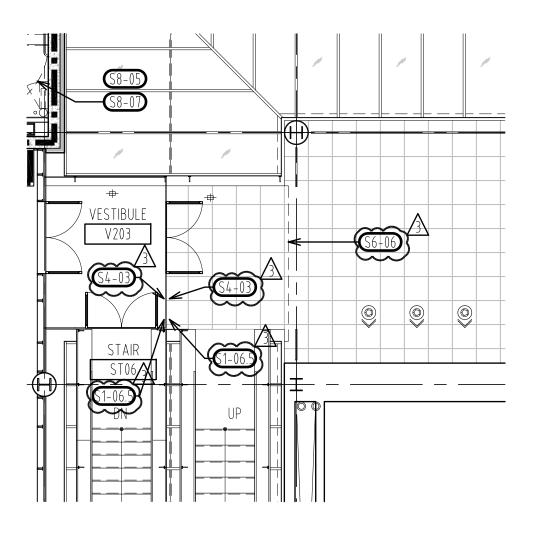

SIGNAGE PLAN LEVEL 2 ZONE D

SCALE : 1/8" = 1'-0"


MOORE SCHOOL OF BUSINESS UNIVERSITY OF SOUTH CAROLINA BID PACKAGE 3 ENCLOSURE/SITE/MEPFP/INTERIOR ADDENDUM #003 PROJECT NO. 655.000


Λ 2012.06.22 © RAFAEL VINOLY ARCHITECTS PC


SIGNAGE PLAN LEVEL 2 ZONE D REF. DWG #SN1120D

SHEET TITLE :

SCALE: 1/8" = 1'-0"

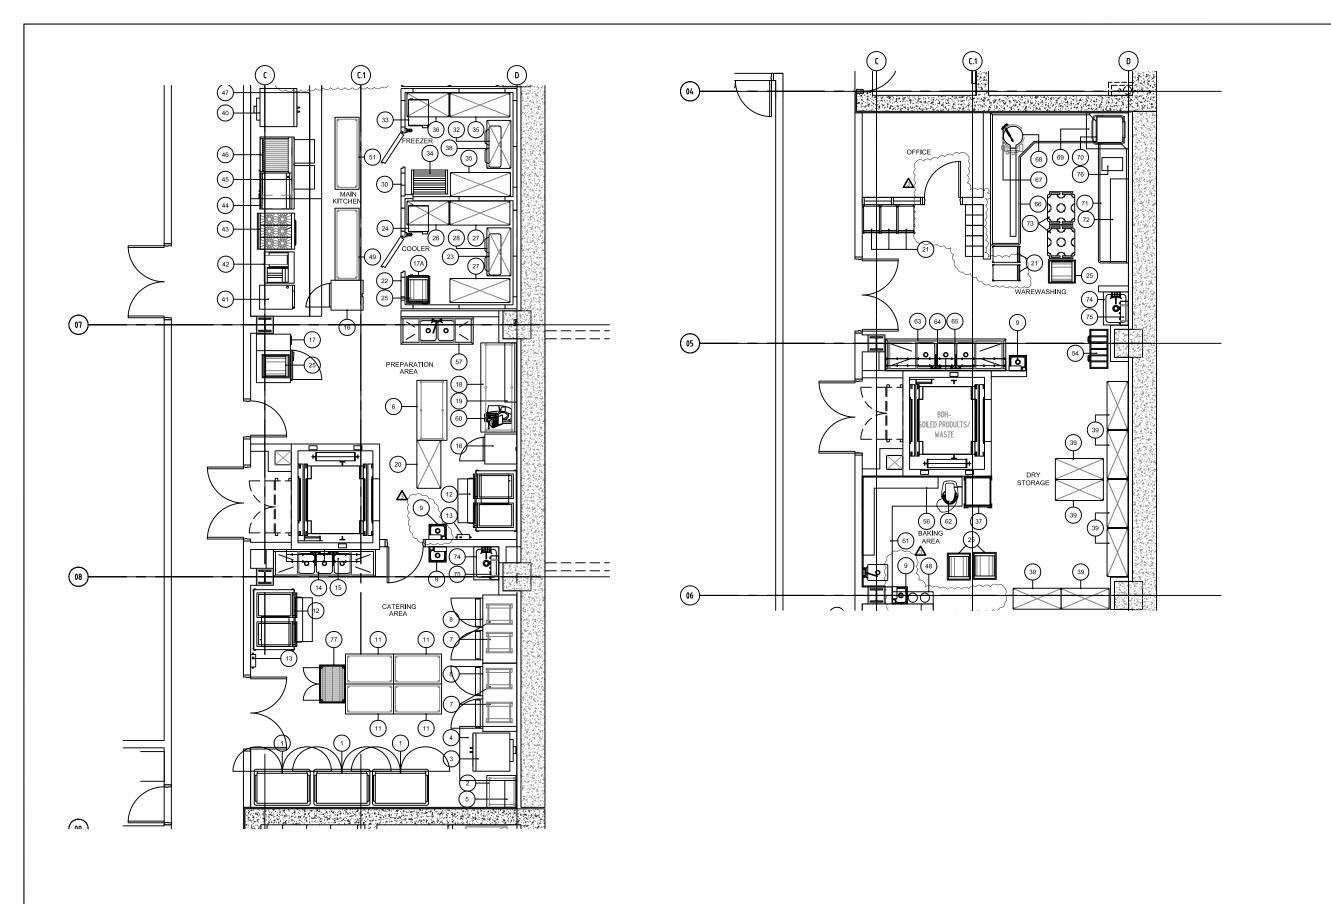


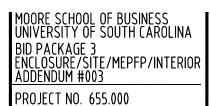


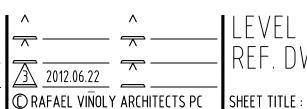

LEVEL O EQUIPMENT LAYOUT PLAN REF. DWG # FS1001

SCALE: 1/8"=1'-0"

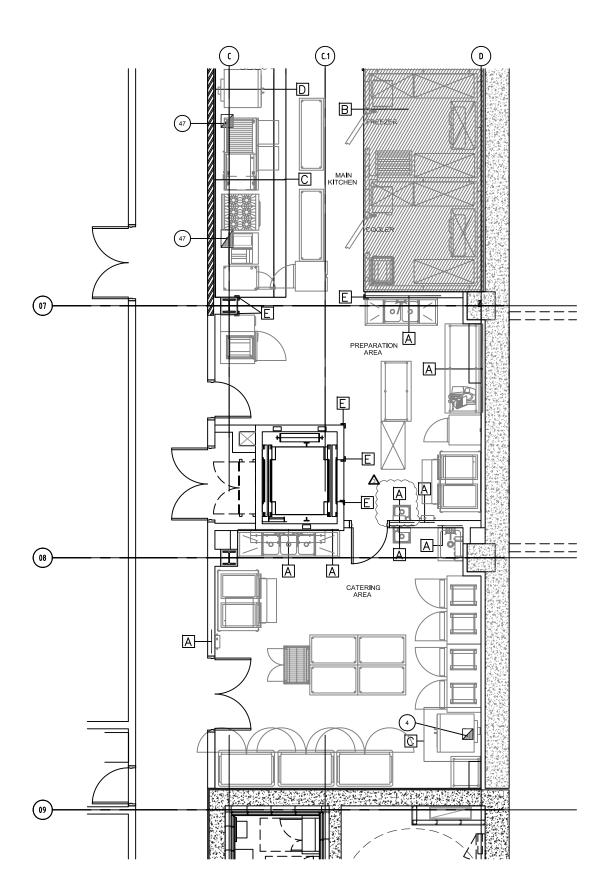


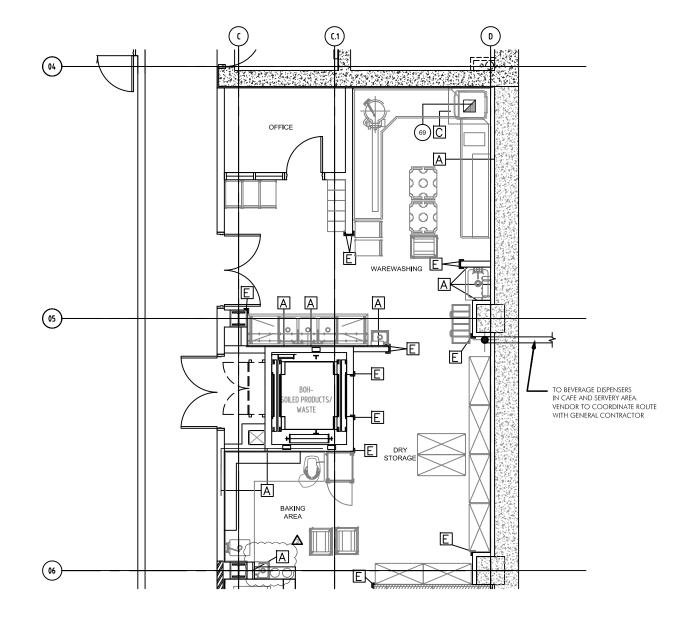

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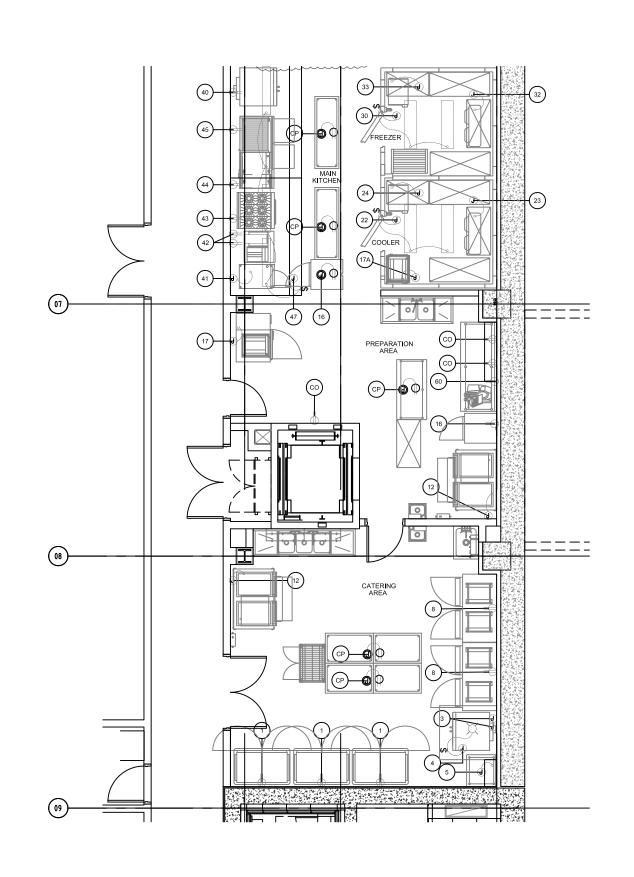
LEVEL O SPECIAL BUILDING CONDITIONS PLAN REF. DWG # FS1002


SCALE: 1/8"=1'-0"

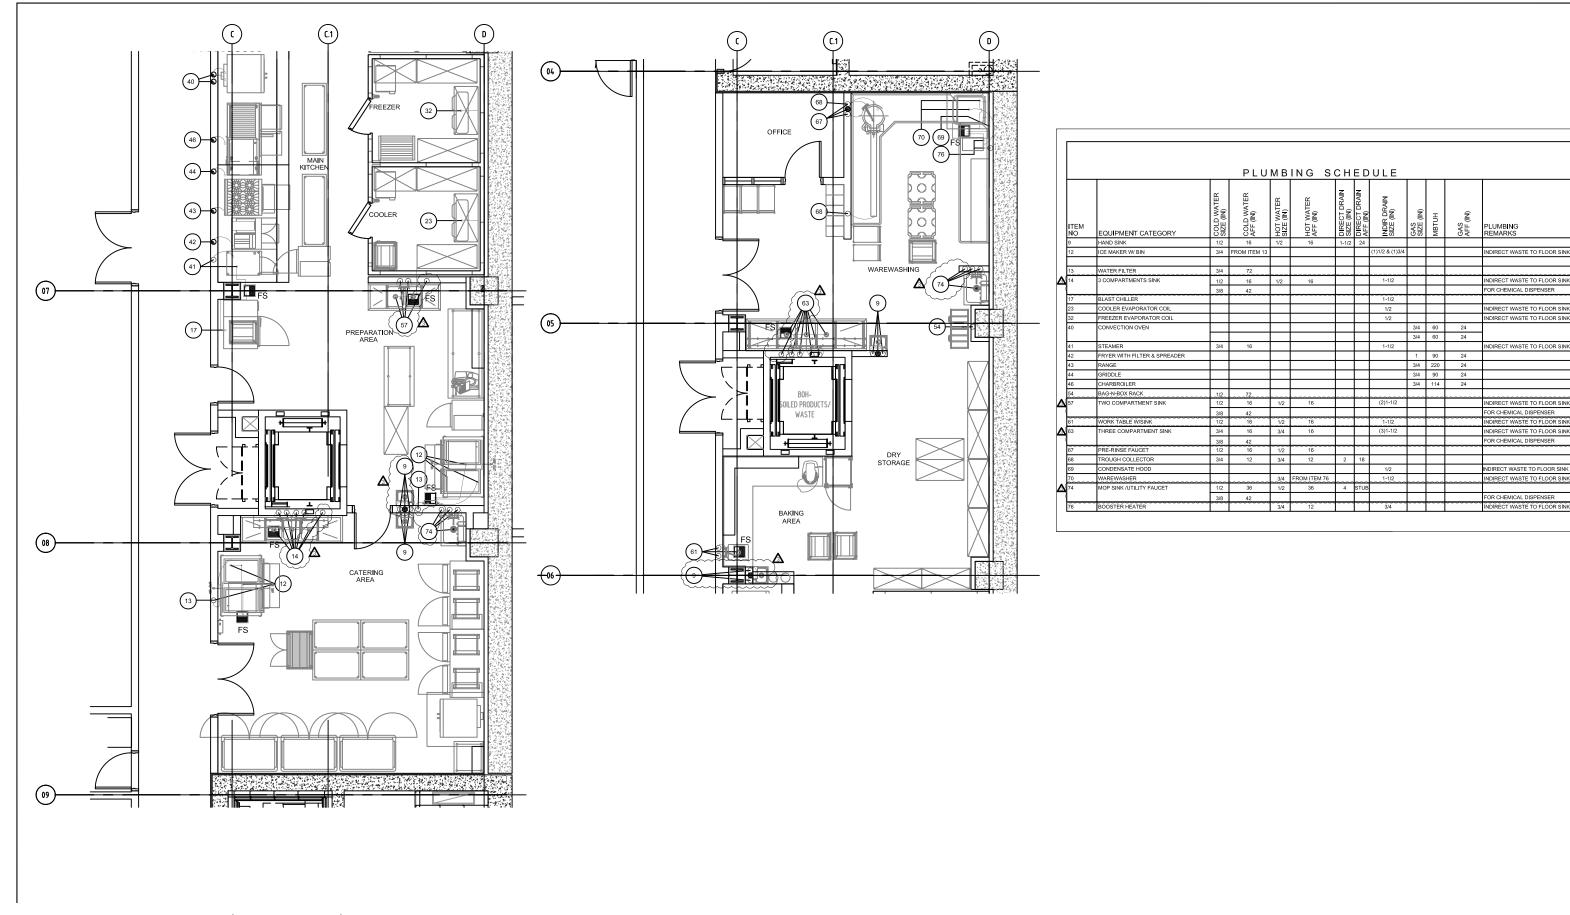

MOORE SCHOOL OF BUSINESS UNIVERSITY OF SOUTH CAROLINA BID PACKAGE 3 ENCLOSURE/SITE/MEPFP/INTERIOR ADDENDUM #003	^ ^	EQUIPMENT PLUMBING PLAN REF. DWG # FS1003
PROJECT NO. 655.000	© RAFAEL VINOLY ARCHITECTS PC	SHEET TITLE :

SCALE : 1/8"=1'-0"




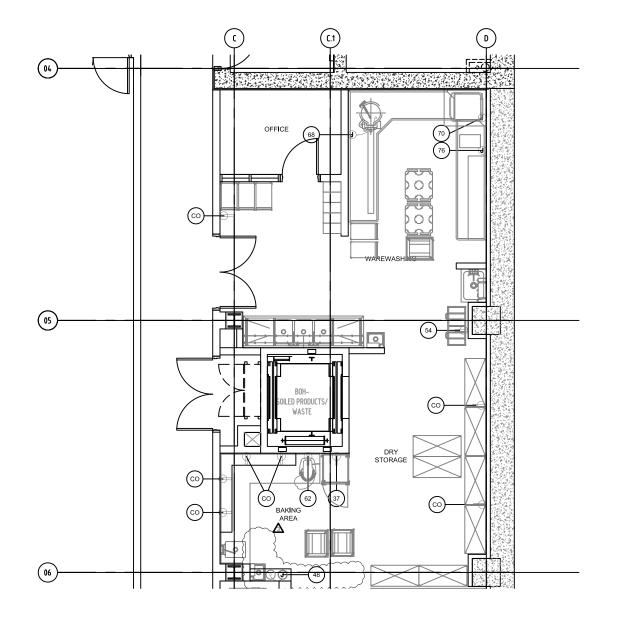

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LEVEL O EQUIPMENT ELECTRICAL PLAN REF. DWG # FS1004

SCALE: 1/8"=1'-0"

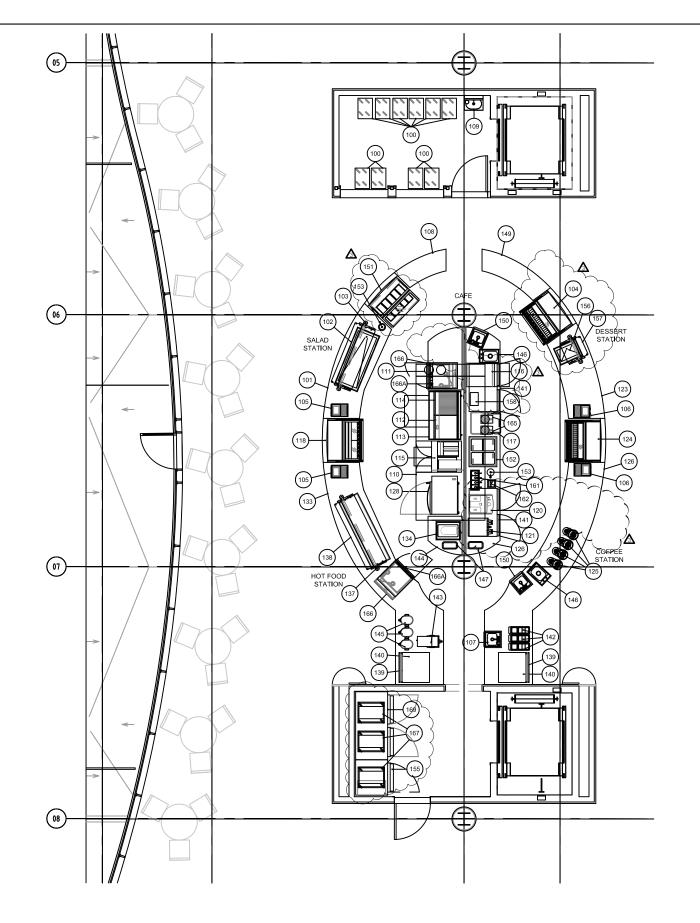


ITEM NO	QTY	EQUIPMENT CATEGORY	EQUIPMENT REMARKS
100	9	TRAY CART	
101	1	SERVING COUNTER	BY GENERAL CONTRACTOR - REFER TO ARCHITECTURAL
102	1	REFRIGERATED WELLS	
103	1	SNEEZE GUARD REFRIGERATED DISPLAY CASE	OPERATOR SERVED
105	2	POINT OF SALE TERMINAL	DFERATOR SERVED
106	2	POINT OF SALE TERMINAL	
107	1	DROP-IN HAND SINK	
108	1	WORK COUNTER	BY GENERAL CONTRACTOR - REFER TO ARCHITECTURA
109	1	HAND SINK	WITH SOAP AND TOWEL DISPENSER
110	1	EXHAUST HOOD	
111	1	FIRE SUPRESSION SYSTEM	
112	1	REFRIGERATED EQUIPMENT STAND	
113	1	GRIDDLE	
114	1	CHARBROILER	
115	1	FRYER WITH FILTER & SPREADER	
116	1	TURBO CHEF OVEN	
117	1	ICE TRANSPORT CART	
118	1	REFRIGERATED DISPLAY CASE	SELF-SERVE
119	<u> </u>	SPARE NUMBER	
120	1	ESPRESSO MACHINE	BY VENDOR
121	1	COFFEE MAKER	BY VENDOR
122	-	SPARE NUMBER	DV CENIEDAL CONTRACTOR, REFER TO ARCHITECTURE
123	1	SERVING COUNTER	BY GENERAL CONTRACTOR - REFER TO ARCHITECTURAL
124 125	4	REFRIGERATED/DRY DISPLAY CASE AIRPOTS	BY VENDOR
126	-	SERVING COUNTER	BY GENERAL CONTRACTOR - REFER TO ARCHITECTURAL
127	1		BY GENERAL CONTRACTOR - REPER TO ARCHITECTURA
128	1	SPARE NUMBER ROTISSERIE	
129	 '	SPARE NUMBER	
130	-	SPARE NUMBER	
131	+-	SPARE NUMBER	
132	-	SPARE NUMBER	
133	1	SERVING COUNTER	BY GENERAL CONTRACTOR - REFER TO ARCHITECTURAL
134	1	SOUP WELL	
135	-	SPARE NUMBER	
136	-	SPARE NUMBER	
137	1	SNEEZE GUARD	
138	1	DROP-IN HEATED SHELF	
139	2	SODA DISPENSER	BY VENDOR
140	2	ICE MAKER	
141	2	UNDERCOUNTER REFRIGERATOR	
142	3	CONDIMENT DISPENSER	
143	1	ICED TEA BREWER	BY VENDOR
144	1	WORK COUNTER	BY GENERAL CONTRACTOR - REFER TO ARCHITECTURAL
145	3	ICED TEA DISPENSER	BY VENDOR
146	2	DROP-IN SINK	
147	2	TRASH CAN	BY OWNER
148	<u> </u>	SPARE NUMBER	
149	1	WORK COUNTER	CUSTOM FABRICATED
150	2	DROP-IN HAND SINK	
151	1	GELATO DISPLAY CASE	
152	1	ICE CREAM DISPLAY CASE	
153 154	2	DIPPERWELL SPARE NUMBER	
154	1		
155 156	1	ROLL-IN REFRIGERATOR DROP-IN COLD WELL	
157	1	SNEEZE GUARD	+
158	1	CONDIMENT CONTAINER	COUNTERTOP
159	÷	SPARE NUMBER	~~~~~~~~~~~~~~~~~~~~~~~~~~~~~~~~~~~~~
160	-	SPARE NUMBER	
161	1	SYRUP RAIL	
162	1	KNOCK BOX	
163	-	SPARE NUMBER	
164	-	SPARE NUMBER	
165	2	BLENDER	
166	2	CARVING STATION	
166A_	2,	UNDERCOUNTER HEATED CABINET	
167	3	UTILITY RACK	
168		SPARE NUMBER	
169	1	ROLL-IN HEATED CABINET	
		SPARE NUMBERS	

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LEVEL 2 EQUIPMENT LAYOUT PLAN REF. DWG # FS1201


SCALE: 1/8"=1'-0"

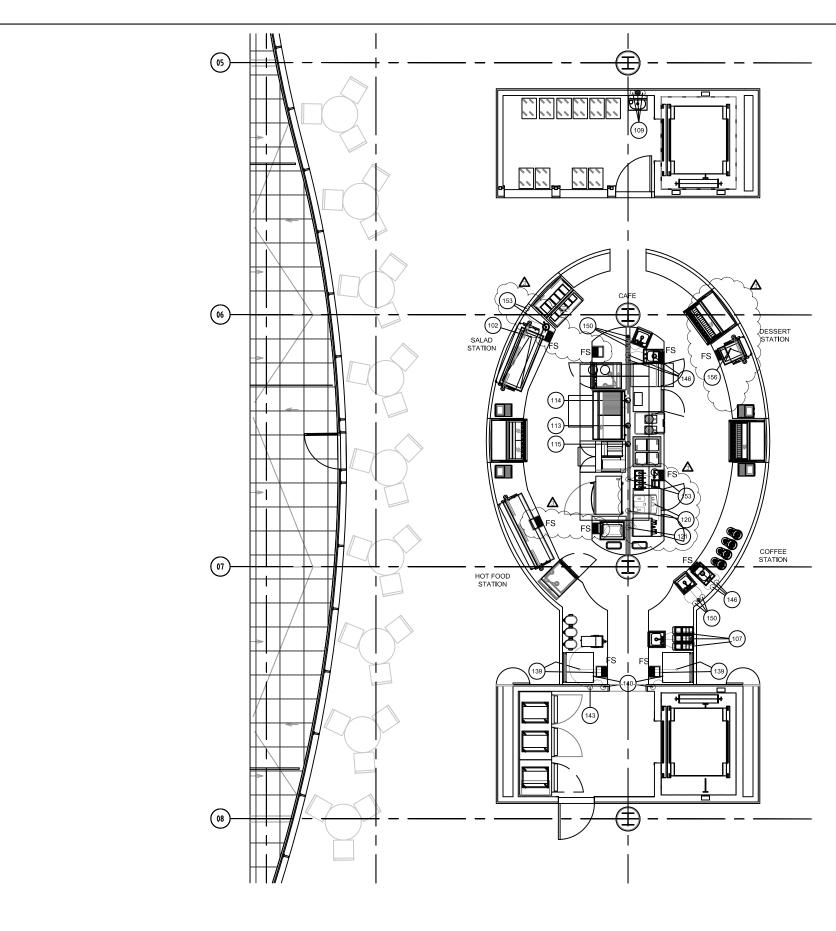

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LEVEL 2 EQUIPMENT PLUMBING PLAN REF. DWG # FS1203

SCALE: 1/8"=1'-0"

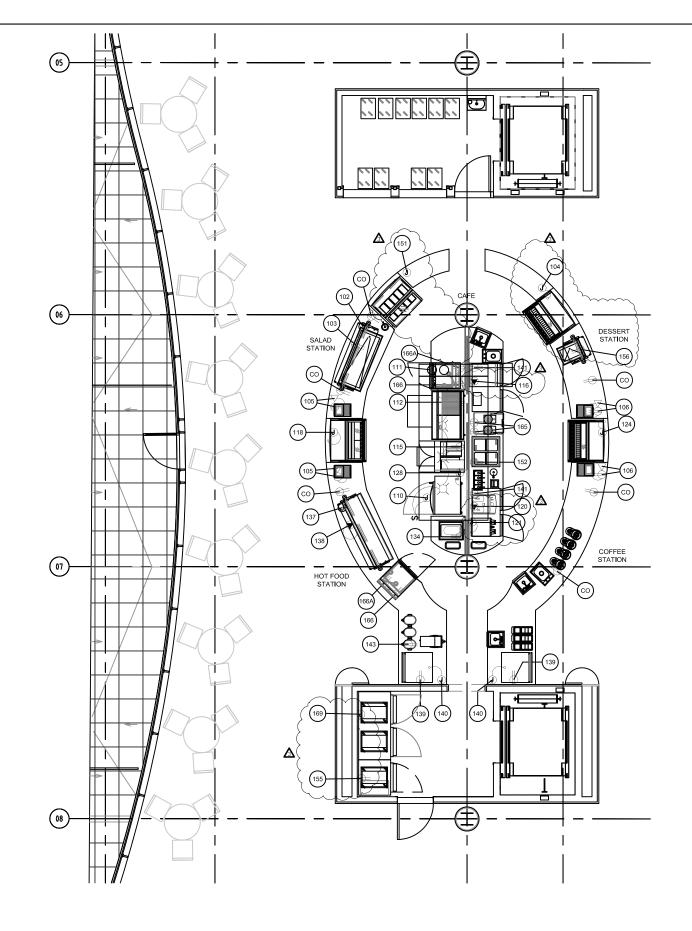


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ITEM NO	EQUIPMENT CATEGORY	AMPS	VOLTS	PHASE	DIRECT	PLUG	NEMA	ELECTRICAL AFF (IN)	ELEC REMARKS
102	DROP-IN COLD FOOD STATION	6.7	120	1		Х	5-15P	18	
103	SNEEZE GUARDS	5.0	120	1	Х			18	LIGHTS
104	REFRIGERATED/DRY DISPLAY CASE	11.0	115	1	Х			18	
105	POINT OF SALE TERMINAL	20.0	120	1		Х	5-20P	18	VERIFY LOAD, INCLUDES TELEPHONE AND DATA RECEPTACL
106	POINT OF SALE TERMINAL	20.0	120	1		Х	5-20P	18	VERIFY LOAD, INCLUDES TELEPHONE AND DATA RECEPTACL
110	EXHAUST HOOD	20.0	120	1	Х			D.F.A	FOR LIGHTS
111	FIRE SUPRESSION SYSTEM	20.0	120	1	Х			D.F.A	DEDICATED CIRCUIT
112	REFRIGERATED EQUIPMENT STAND	8.1	115	1		Х	5-15P	18	
115	FRYER WITH FILTER & SPREADER	7.5	120			Х		18	
116	TURBO CHEF OVEN	40.0	208	1		Х	6-50P	18	
118	DISPLAY CASE REFRIGERATED	8.0	115	1	Х			18	
120	ESPRESSO MACHINE	30.0	208	1		Х	L6-30P	18	
121	COFFEE MAKER	28.7	120/208	1	Х			18	
124	REFRIGERATED/DRY DISPLAY CASE	11.0	115	1	Х			18	
128	ROTISSERIE	40.0	208	1	Х			18	
134	SOUP WELL	4.2	120	1		Х	5-15P	18	
137	SNEEZE GUARDS	5.0	120	1	Х			18	LIGHTS/HEAT LAMP
138	DROP-IN HEATED SHELF	14.1	208	1		Х	6-15P	18	
139	SODA DISPENSER	2.5	120	1		Х	5-15P	18	VENDOR TO VERIFY LOAD
140	ICE MAKER	10.2	208	1	Х			18	
141	UNDERCOUNTER REFRIGERATOR	3.3	115	1		Х	5-15P	18	
143	ICED TEA BREWER	14.8	120	1		Х	5-15P	18	MOUNTED IN COUNTER BASE
151	GELATO DISPLAY CASE	5.5	208	1	Х			18	
152	ICE CREAM DISPLAY CASE	5.3	120	1		Х	5-15P	18	
155	ROLL-IN REFRIGERATOR	10.6	120	1		Х	5-15P	90	
156	DROP-IN COLD FOOD STATION	4.2	120	1		Х	5-15P	18	
165	BLENDER	10.0	120	1		Х	5-15P	18	
166	CARVING STATION	6.3	120	1		Х	5-15P	18	
166A	UNDERCOUNTER HEATED CABINET	14.1	120	1		X	5-15P	18	
169	ROLL-IN HEATED CABINET	15.5	120/208	1	Х	Х		90	
\sim	CONVENIENCE OUTLET	20.0	120	7	P	$\overline{\mathbf{x}}$	5-20P	18	~~~~~~~~~~~~~~~~~~~~~~~~~~~~~~~~~~~~~

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LEVEL 2 EQUIPMENT ELECTRICAL PLAN REF. DWG # FS1204

SCALE: 1/8"=1'-0"

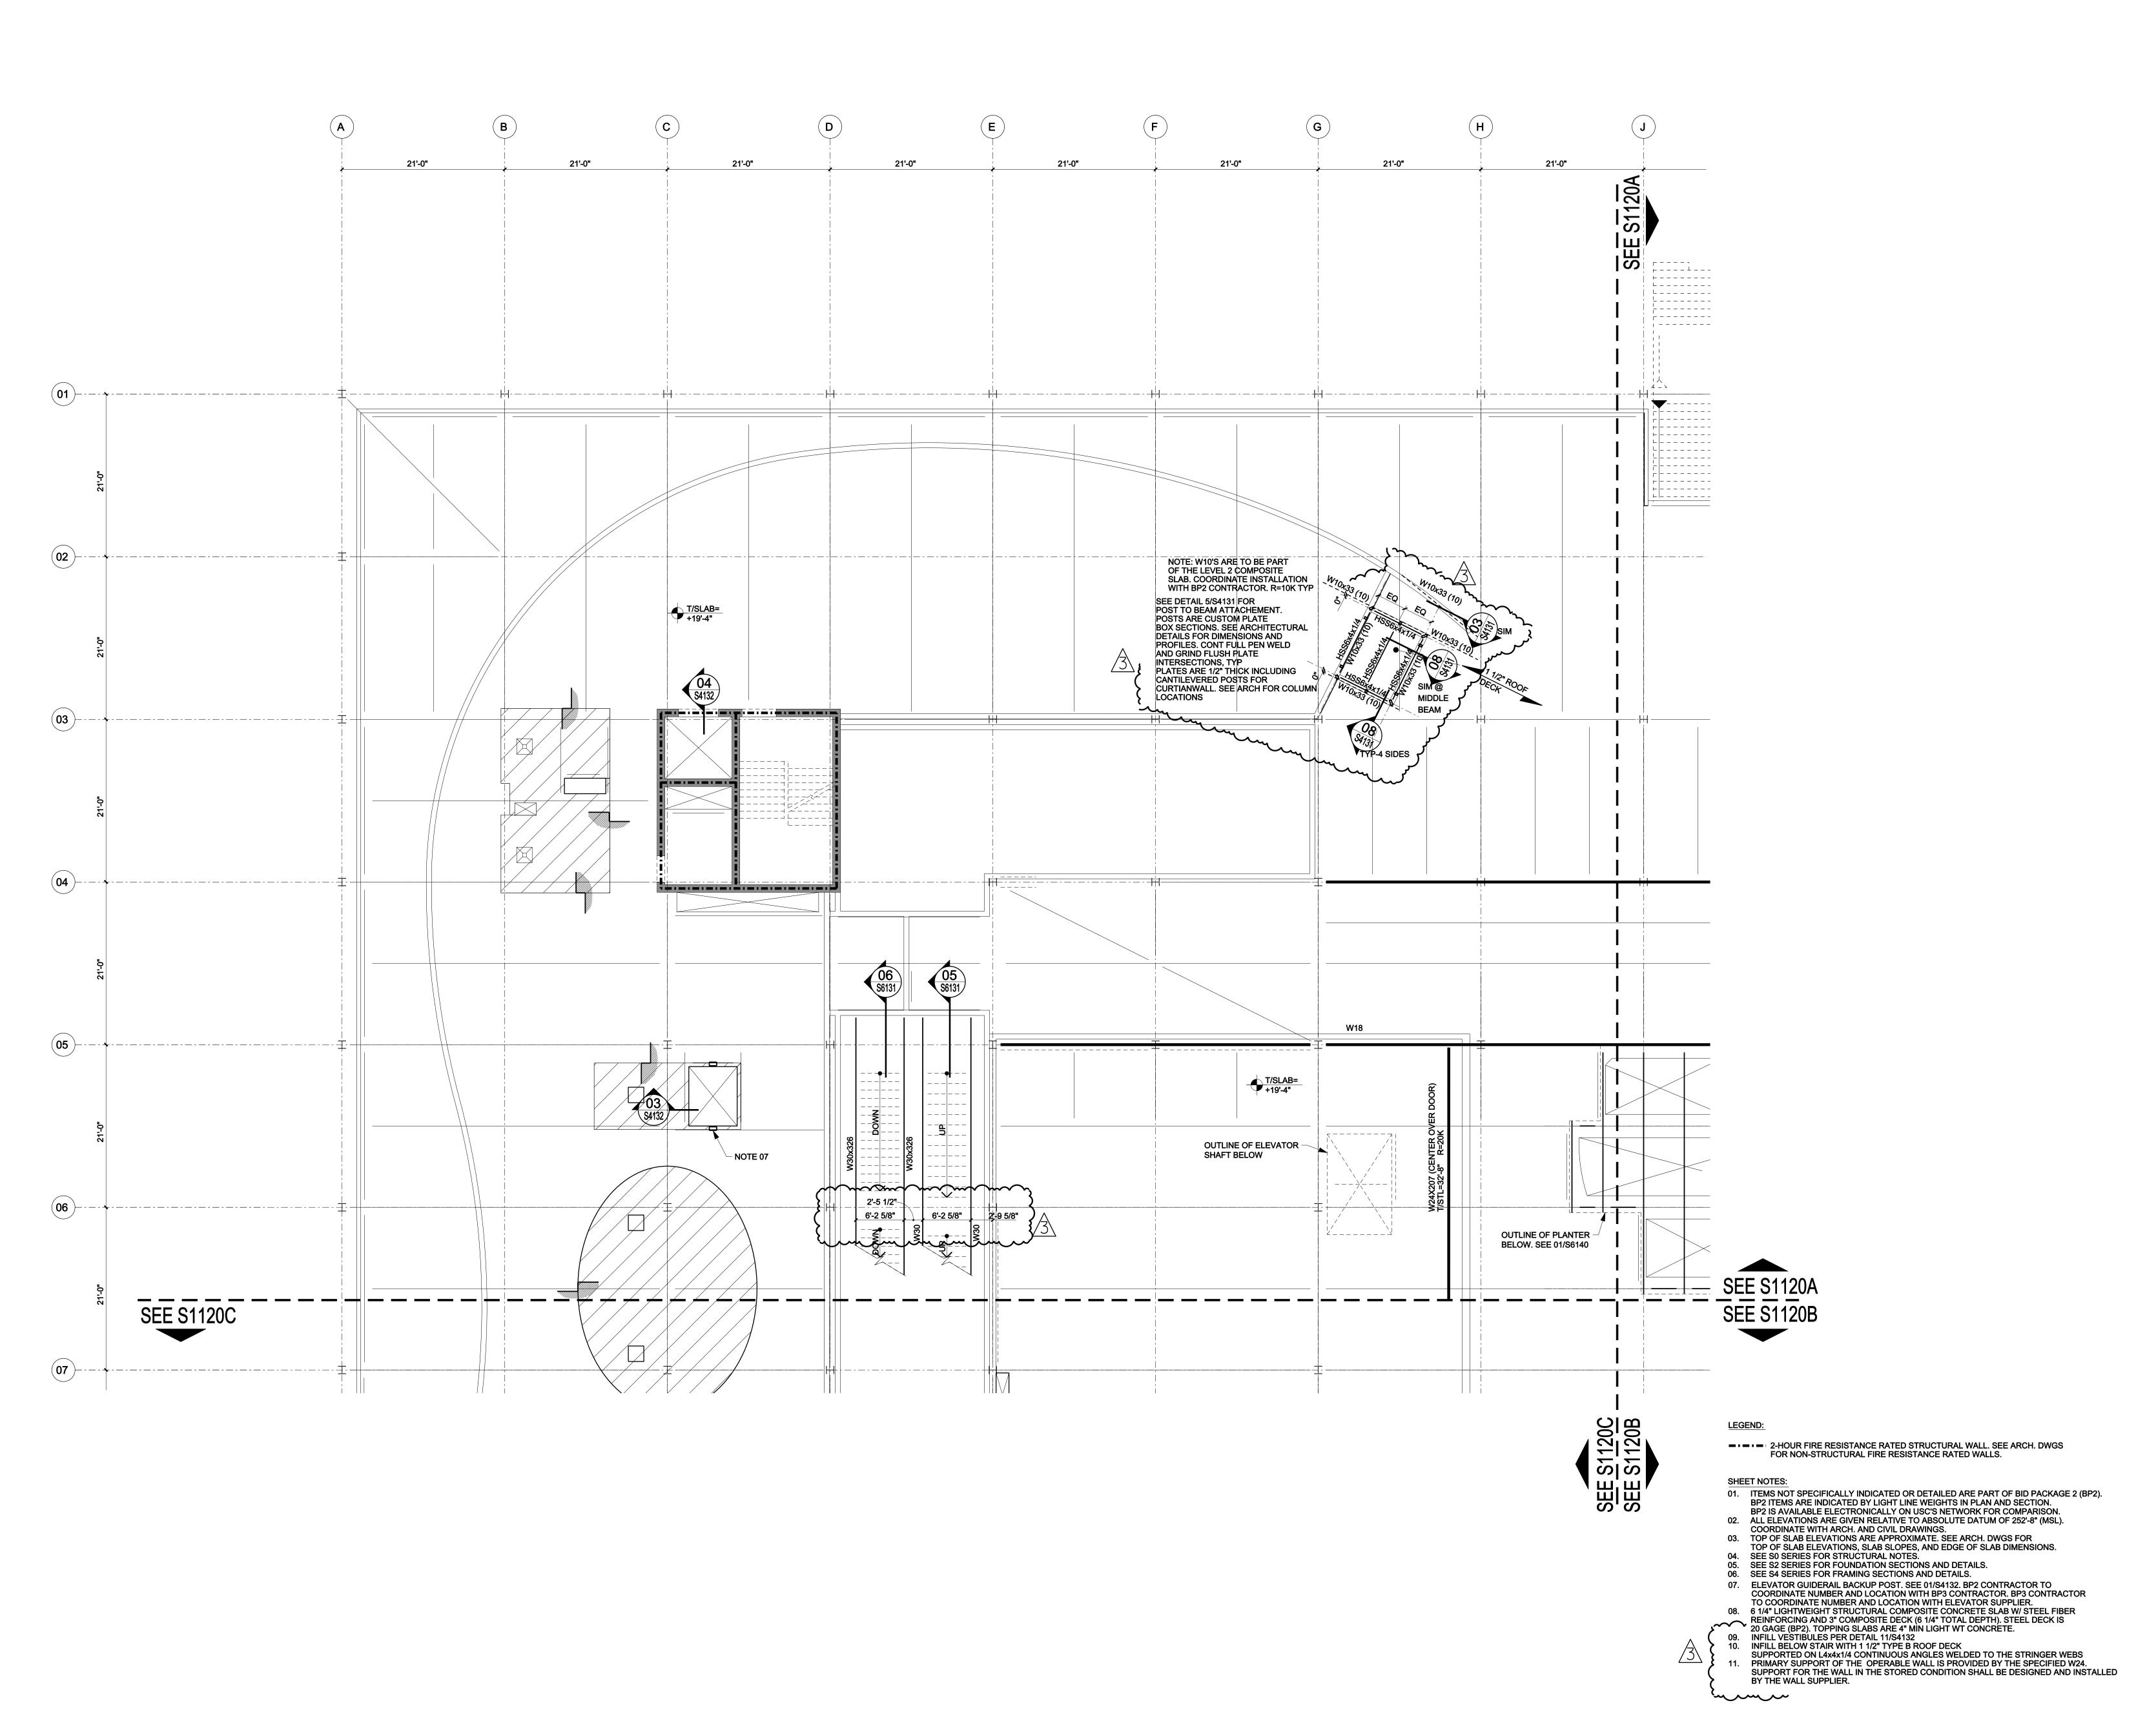

ON BEHALF OF USC CAMPUS PLANNING & CONSTRUCTION

PROJECT NAME:
UNIVERSITY OF SOUTH CAROLINA
DARLA MOORE SCHOOL OF BUSINESS CONSTRUCTION

UNIVERSITY OF SOUTH CAROLINA
DARLA MOORE SCHOOL OF BUSINESS CONSTRUC

OSE PROJECT NUMBER:
H27-6069-AC-3

USC BUSINESS PARTNERSHIP FOUNDATION

743 GREENE STREET
COLUMBIA, SC 20298
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RAFAEL VINOLY ARCHITECTS PC 50 VANDAM STREET NEW YORK, NY 10013 TEL: 212 924 5060 FAX: 212 924 5858 STRUCTURAL ENGINEER, MEP ENGINEER, CIVIL ENGINEER, FIRE PROTECTION

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COLUMBIA, SC 29201-5801
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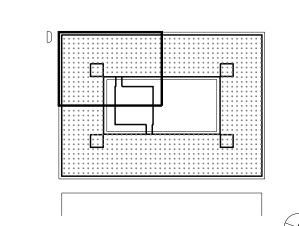
SPECIFICATIONS:
ROBERT SCHWARTZ & ASSOCIATES

SPECIFICATIONS:
ROBERT SCHWARTZ & ASSOCIATES
589 8TH. AVE., 17TH. FLOOR
NEW YORK, NY 10018
TEL: 212 691 3248 FAX: 212 633 1613


BID PACKAGE 3
ENCLOSURE/SITE/MEPFP/INTERI
MAY 14, 2012

DHASE -

SEAL & SIGNATURE




KEY PLAN & NORTH SIGN

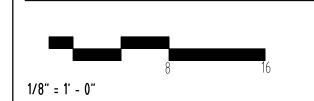


FRAMING PLAN LEVEL 2

SHEET TITLE:

1120D_b3

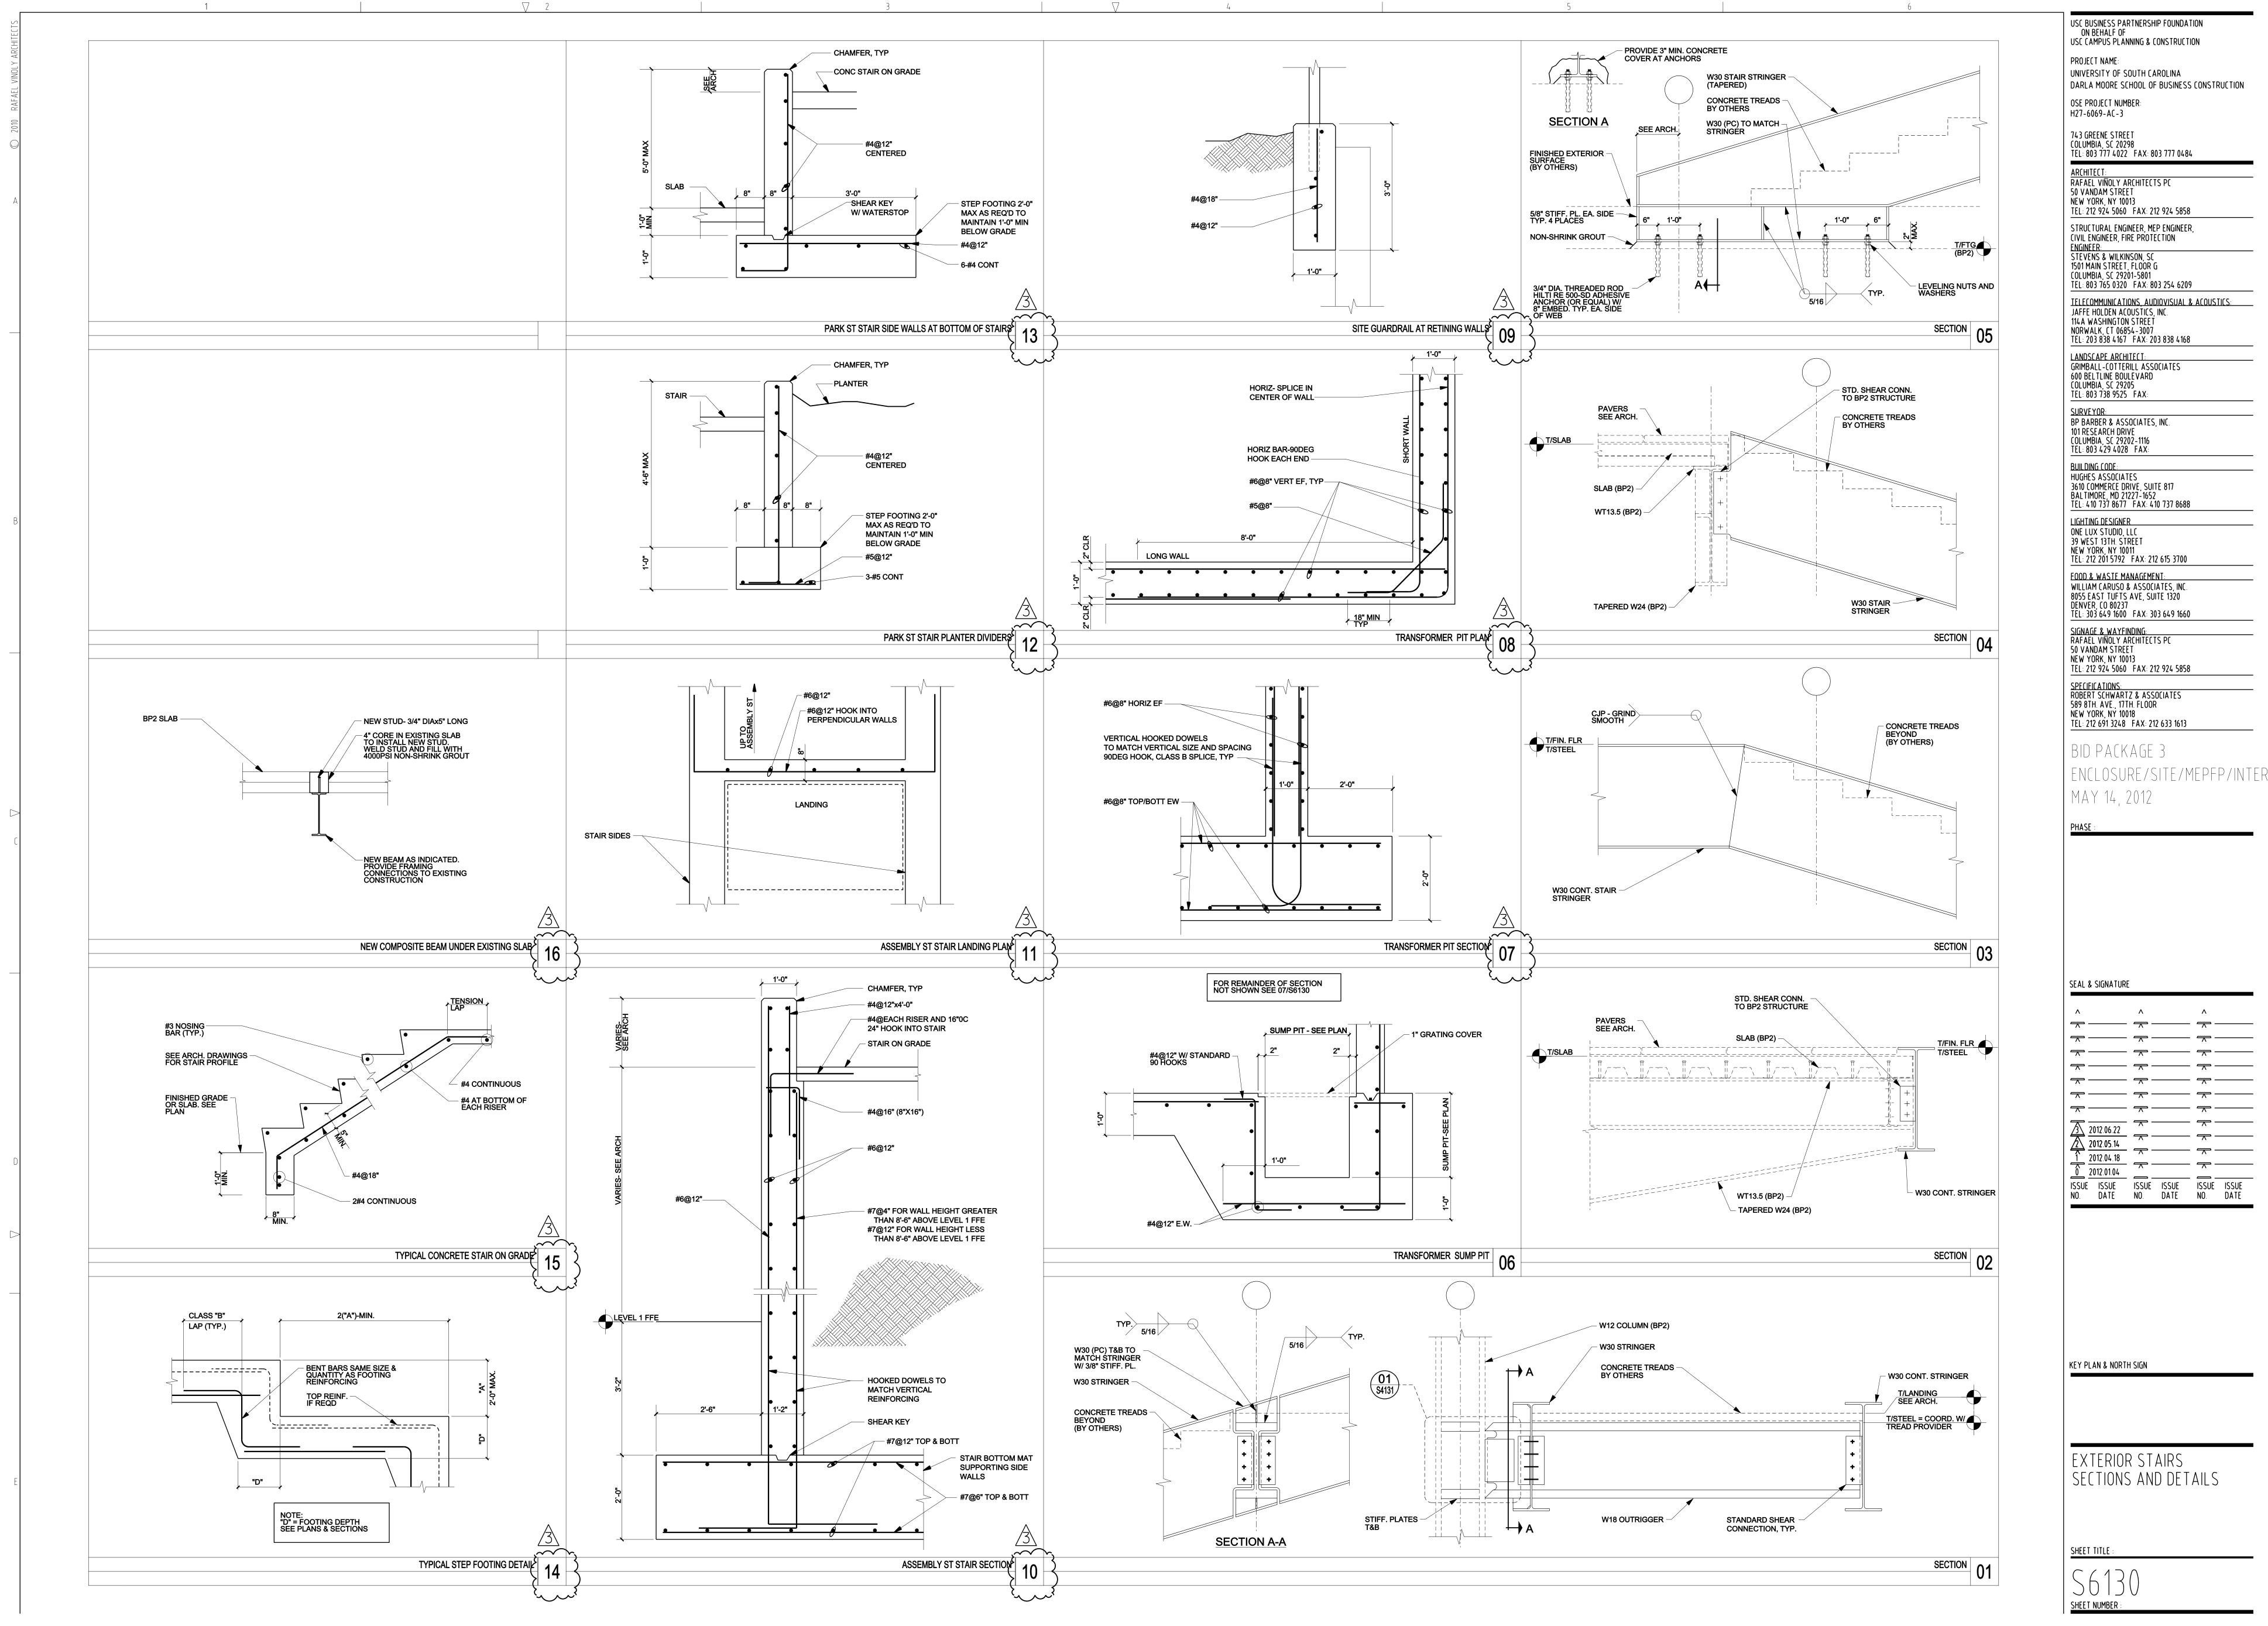

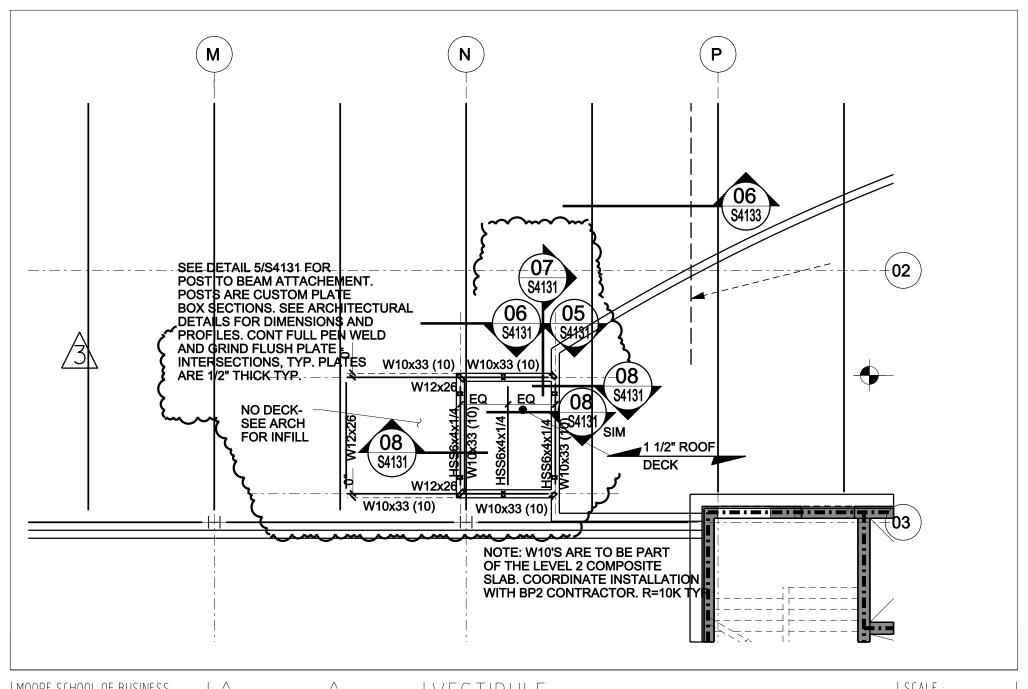

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| VESTIBULE | REF. DWG # S1120A_bp3

SHEET TITLE :

SCALE : NOT TO SCALE

SEE SITE STEAM PIPING PLAN M2300 FOR CONTINUATION. 8" HIGH PRESSURE STEAM & 4" PUMPED CONDENSATE RETURN STACKED. COORDINATE ROUTE BETWEEN STRUCTURAL FOOTINGS. 8" HIGH PRESSURE STEAM BELOW -GRADE. SEE SPECIFICATIONS FOR PRE-INSULATED BELOW GRADE 4" PUMPED CONDENSATE STEAM PIPE. munum 6" CHWS & CHWR DOWN FROM LEVEL 1 — 2" CBS & CBR DOWN FROM LEVEL 1 6" HHWS & HHWR UP TO LEVEL 1 4" COND. RETURN. INV. @ 244.67'. PIPE BANK INV.=249' 14" SLEEVE FOR 6" PIPES, PROVIDE WITH 14" SLEEVE. 10" SLEEVES FOR 2" PIPES. 8" STEAM. INV @ 244.67'. PROVIDE WITH 22" SLEEVE. SEE BUILDING STEAM ENTRANCE DETAIL 2/M4102 STEAM VAULT SUMP PUMP — ALARM PANELS. DROPS TO AHU-108 SEE 2/M2300 FOR 1 1/2" HHWS & HHWR REQUIRMENTS. DROPS TO AHU-109 2 1/2" HHWS & HHWR [[] DROPS TO AHU-108 1 1/2" HHWS & HHWR DROPS TO AHU-109 AHU-109 3" STEAM VENT INV.=247.67' AFF. PROVIDE WITH 14" SLEEVE. 3" HHWS & 4"CHWS & AHU-108 _DROPS TO DROPS TO DOAS-02 2" CHWS & CHWR - ROUTE PIPE UP IN SPACE B/T FINISHED WALL & DROPS TO AHU-109 -SHOTCRETE RETAINING WALL. SEE M1200F ____ 6" LOW PRESSURE STEAM RELIEF VENT 4" MEDIUM PRESSURE STEAM RELIEF VENT. -4" -4"

MECHANICAL PIPING KEYNOTES

1. RUNOUTS TO INDIVIDUAL DEVICES ARE NOT SHOWN FOR CLARITY.

4. PROVIDE FLEXIBLE CONNECTIONS, SHUT-OFF VALVES AND UNIONS

5. ROUTE CONDENSATE FROM EQUIPMENT RECEIVING 43 DEGREE

RISERS. CONDENSATE PIPE SHALL BE 3/4" OR MATCH THE

6. CONTRACTOR TO COORDINATE PIPE ROUTING IN CHASE PROVIDED WITH OTHER DISCIPLINES.
7. PROVIDE SHUT-OFF VALVES ON ALL SERVICES AS THEY LEAVE THE

8. SEE SPECIFICATION 23 57 00 FOR PACKAGED HEATING HOT WATER

EQUIPMENT DRAIN SIZE, WHICHEVER IS GREATER.

SYSTEM, PROVIDED BY MECHANICAL CONTRACTOR.

B. PROVIDE 1/2" RUNOUTS FOR FLOWS LESS THAN OR EQUAL TO 1 GPM.

PROVIDE 3/4" RUNOUTS FOR FLOWS GREATER THAN 1 GPM UP TO 3 GPM. PROVIDE 1" RUNOUTS FOR FLOWS GREATER THAN 3 GPM UP

TO 6 GPM. PROVIDE 1 1/2" RUNOUTS FOR FLOWS GREATER THAN 6

WATER TO THE NEAREST FLOOR SINK, MOP SINK OR CONDENSATE

2. SEE DUCT PLANS FOR EQUIPMENT TAGS NOT SHOWN.

 KEYNOTE
 NOTE

 MP1
 PROVIDE 3/4" REVERSE RETURN LOOP TO DEVICES INDICATED

HVAC PIPING NOTES:

GPM UP TO 16 GPM.

TO EACH PIECE OF EQUIPMENT.

ON BEHALF OF USC CAMPUS PLANNING & CONSTRUCTION

PROJECT NAME:
UNIVERSITY OF SOUTH CAROLINA
DARLA MOORE SCHOOL OF BUSINESS CONSTRUCTION
OSE PROJECT NUMBER:

USC BUSINESS PARTNERSHIP FOUNDATION

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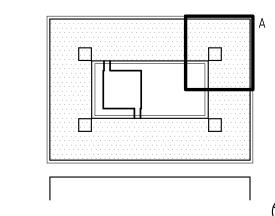
SPECIFICATIONS:
ROBERT SCHWARTZ & ASSOCIATES
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BID PACKAGE 3
ENCLOSURE/SITE/MEPFP/INTERIOR
MAY 14, 2012

PHASE:

SEAL & SIGNATURE

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ISSUE ISSUE		SUE ISSUE	ISSUE
NO. DATE	NO. DA	ATE NO.	DATE



KEY PLAN & NORTH SIGN



HVAC PIPING PLAN -LEVEL 0 - ZONE A

SHEET TITLE

SHEET NUMBER:

ENLARGED VAULT PLAN KEY NOTES:

(01) CONTRACTOR TO FIELD VERIFY ALL EXISTING PIPE SIZES, LOCATIONS AND CONDITIONS. PROVIDE LARGE SCALE COORDINATION DRAWINGS FOR APPROVAL OF WORK INSIDE VAULTS "A" AND "B". COORDINATE ALL REQUIRED STEAM OUTAGES WITH UNIVERSITY ENGINEERING SERVICES.

(02) REMOVE EXISTING 10" DRIP LEG AND 10" TO 8" REDUCER IN VAULT "A".

(03) REMOVE EXISTING 8" HIGH PRESSURE STEAM HEADER INCLUDING ALL ASSOCIATED TAPS AND VALVES TO THE KOGER CENTER, SCHOOL OF MUSIC AND DISCOVERY IN VAULT "A".

(04) PROVIDE NEW 10" FLANGED HIGH PRESSURE STEAM ISOLATION VALVE AT THE ENTRANCE TO VAULT "A".

(05) PROVIDE NEW 10" STEAM HEADER WITH THE FOLLOWING IN VAULT "A": A. 10" INLET AND OUTLET ISOLATION VALVES. B. BALANCED PRESSURE THERMOSTATIC AIR VENT. C. NEW 10"DIA. DRIP LEG WITH BOTTOM FLANGED END CAP, DRAIN TAP, SUPERVISED START-UP VALVE, LIQUID EXPANSION STEAM TRAP, DRIP LEG SIDE TAP WITH LOSS DETECTOR, STRAINER WITH BLOW-DOWN, THERMODYNAMIC STEAM TRAP, CHECK VALVE, UNIONS AND ISOLATION VALVES FOR THE STRAINER/TRAP/CHECK SET ASSEMBLY.

PROVIDE SUMP PUMP FOR DE-WATERING VAULT "A". PROVIDE 2" DISCHARGE PIPING TO THE NEAREST STORM DRAIN CATCH BASIN LOCATED ON THE DMBS SITE. PUMP TO BE A BARNES MODEL EH512HT SUBMERSIBLE PUMP WITH BARNES ESPS-150 FLOAT SWITCH (WITH FREE STAND BASE), BARNES 1500 HIGH LEVEL ALARM PANEL LOCATED IN DMBS MECHANICAL ROOM AND ALARM CONNECTIONS TO THE BUILDING BMS.

D. NEW 4" HIGH PRESSURE STEAM TAP WITH ISOLATION VALVE TO SERVE THE SCHOOL OF MUSIC. E. NEW 6" HIGH PRESSURE STEAM TAP WITH ISOLATION VALVE TO SERVE THE KOGER CENTER.

(07) REMOVE 8" HIGH PRESSURE STEAM LINE BETWEEN VAULTS "A" AND "B".

(08) REMOVE EXISTING 8" HIGH PRESSURE STEAM LINE INSIDE OF VAULT "B".

 $\langle 09
angle$ Increase existing opening in the side of the vault "A" to accommodate the New 10" steam line,

DOUBLE WALL INSULATION AND LINK SEAL TO FEED VAULT "B"...

10 INCREASE EXISTING OPENING IN THE SIDE OF THE VAULT "B" TO ACCOMMODATE THE NEW 10" STEAM LINE, DOUBLE WALL INSULATION AND LINK SEAL.

(11) PROVIDE NEW 10" HIGH PRESSURE STEAM MAIN FROM VAULT "A" TO VAULT "B".

(12) PROVIDE NEW 10" FLANGED HIGH PRESSURE STEAM ISOLATION VALVE AT THE ENTRANCE TO VAULT "B". (13) PROVIDE NEW 10" HIGH PRESSURE STEAM MAIN THROUGH VAULT "B".

PROVIDE NEW 8" HIGH PRESSURE STEAM TAP WITH ISOLATION VALVE TO SERVE THE DMBS INSIDE VAULT "B" OFF THE NEW 10" HIGH PRESSURE STEAM MAIN IN VAULT "B".

PROVIDE NEW 8"DIA. DRIP LEG WITH BOTTOM FLANGED END CAP, DRAIN TAP, SUPERVISED START-UP VALVE, LIQUID EXPANSION STEAM TRAP, DRIP LEG SIDE TAP WITH LOSS DETECTOR, STRAINER WITH BLOW-DOWN, THERMODYNAMIC STEAM TRAP, CHECK VALVE, UNIONS AND ISOLATION VALVES FOR THE STRAINER/TRAP/CHECK SET ASSEMBLY.

(16) PROVIDE A 10" TO 8" REDUCER ON THE HIGH PRESSURE STEAM LINE IN VAULT "B" TO "DISCOVERY".

(17) PROVIDE A NEW 8" FLANGED HIGH PRESSURE STEAM ISOLATION VALVE FOR DISCOVERY IN VAULT "B"

4" PUMPED CONDENSATE RETURN FROM THE DMBS TO BE TAPPED INTO THE TOP OF THE EXISTING CONDENSATE RETURN WITH A "SWEPT TEE" IN VAULT "B".


(19) PROVIDE SUMP PUMP FOR DE-WATERING VAULT "B". PROVIDE 2" DISCHARGE PIPING TO THE NEAREST STORM DRAIN CATCH BASIN LOCATED ON THE DMBS SITE. PUMP TO BE A BARNES MODEL EH512HT SUBMERSIBLE PUMP WITH BARNES ESPS-150 FLOAT SWITCH (WITH FREE STAND BASE), BARNES 1500 HIGH LEVEL ALARM PANEL LOCATED IN DMBS MECHANICAL ROOM AND ALARM CONNECTIONS TO THE BUILDING BMS.

20 PROVIDE LINK-SEAL MODULAR SEALS AT EACH STEAM, CONDENSATE RETURN PIPING AND SUMP PUMP DISCHARGE PIPE PENETRATION IN THE WALLS OF VAULTS "A" AND "B".

21) ALL EXISTING STEAM, CONDENSATE AND CHILLED WATER PIPING INSIDE BOTH VAULTS "A" AND "B" ARE TO BE RE-INSULATED.

CONTRACTOR SHALL BE RESPONSIBLE FOR TRAFFIC CONTROL AND STORM WATER RUNOFF CONTROL. IF NECESSARY CONTRACTOR SHALL PROVIDE STRUCTURAL SUPPORT FOR ALL ADJACENT UTILITIES.

23 PROVIDE STAINLESS STEEL NEMA4X SUMP PUMP SAFETY DISCONNECT SWITCH IN VAULT.

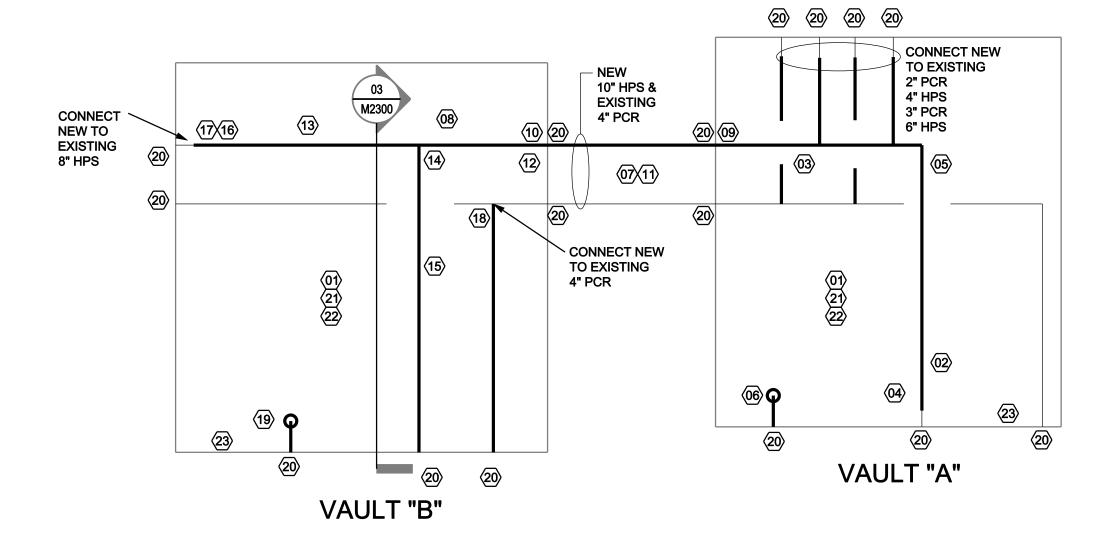

ENLARGED VAULT STEAM AND CONDENSATE PIPING PLAN SCALE : 1/4" = 1'- 0"

SCALE : NONE -8" STEAM SUPPLY TO DMBS CHWS&R LINES TO REMAIN - INSULATION 8" STEAM OFF VALVE (CONDENSATE RETURN SHUT-OFF VALVE NOT SHOWN) SUPPLY ∕─VAULT WALL 1. CONDENSATE RETURN PIPING IS SHOWN OFF-SET FOR CLARITY SAKE.
2. ALL OTHER PIPING ACCESSORIES ARE NOT SHOWN FOR CLARITY SAKE.

VAULT B SECTION

SCALE : NONE

EXISTING 4" PUMPED CONDENSATE RETURN

DMBS 4" PUMPED CONDENSATE RETURN

TRAP PER SPECIFICATIONS ———

GATE VALVE (TYP)


8" DIRT LEG, 16" LONG

WITH 2" BLOW DOWN,

SECTION GENERAL NOTES:

VALVE, NIPPLE AND CAP.

NEW 10" HIGH PRESSURE STEAM

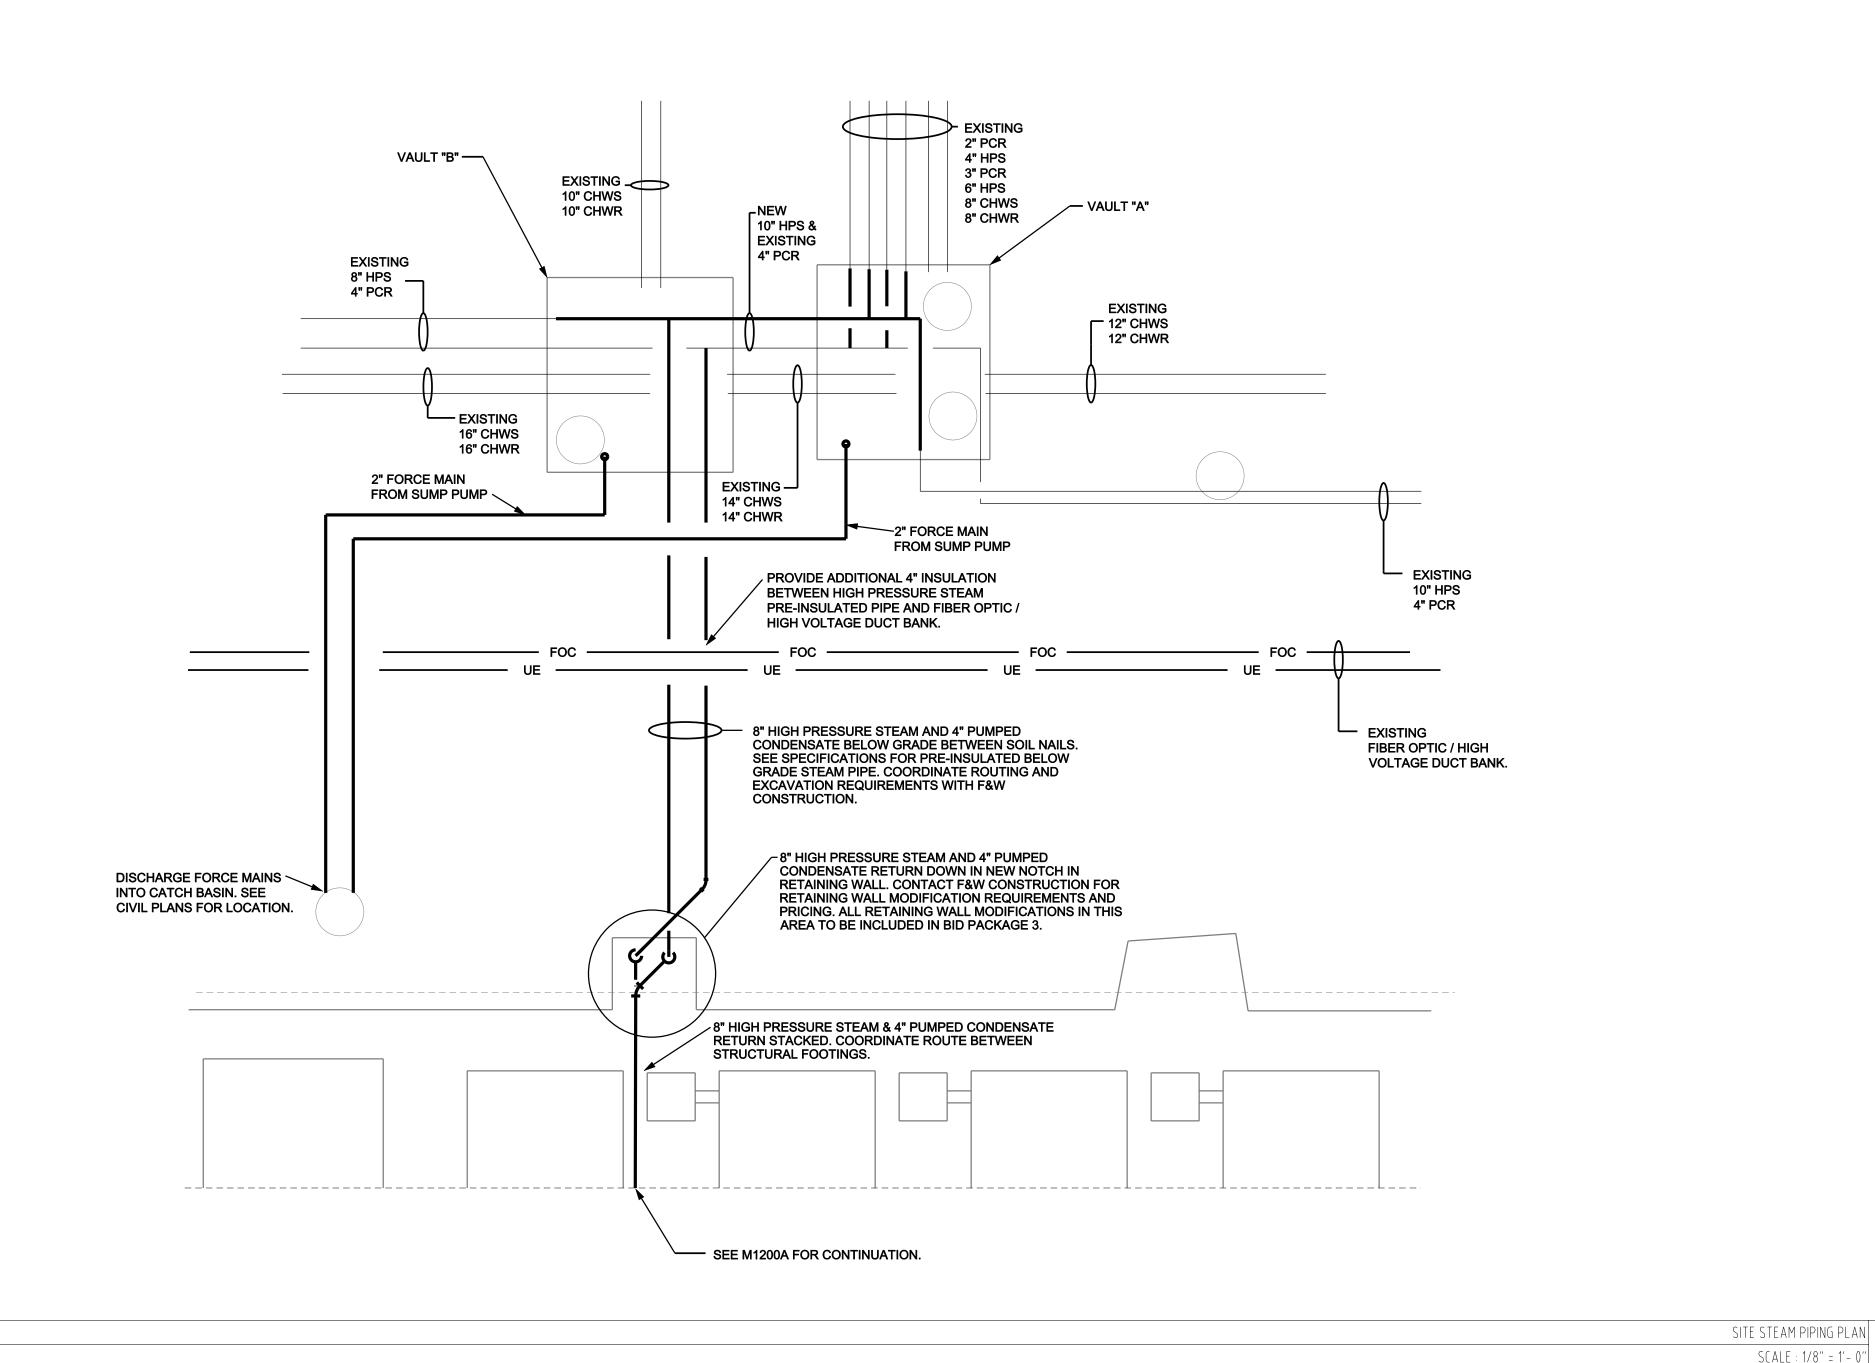

ISSUE ISSUE ISSUE ISSUE ISSUE NO. DATE NO. DATE NO. DATE

USC BUSINESS PARTNERSHIP FOUNDATION

USC CAMPUS PLANNING & CONSTRUCTION

DARLA MOORE SCHOOL OF BUSINESS CONSTRUCTION

UNIVERSITY OF SOUTH CAROLINA

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STRUCTURAL ENGINEER, MEP ENGINEER.

TEL: 803 765 0320 FAX: 803 254 6209

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GRIMBALL-COTTERILL ASSOCIATES

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JAFFE HOLDEN ACOUSTICS INC. 114A WASHINGTON STREET

NORWALK, CT 06854-3007

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600 BELTLINE BOULEVARD

COLUMBIA, SC 29205 TEL: 803 738 9525 FAX:

101 RESEARCH DRIVE

HUGHES ASSOCIATES

LIGHTING DESIGNER

ONE LUX STUDIO, LLC 39 WEST 13TH STREET

NEW YORK, NY 10011

DENVER, CO 80237

50 VANDAM STREET

NEW YORK NY 10013

BUILDING CODE:

COLUMBIA, SC 29202-1116 TEL: 803 429 4028 FAX:

BP BARBER & ASSOCIATES, INC.

3610 COMMERCE DRIVE, SUITE 817 BALTIMORE, MD 21227-1652 TEL: 410 737 8677 FAX: 410 737 8688

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ROBERT SCHWARTZ & ASSOCIATES 589 8TH. AVE., 17TH. FLOOR NEW YORK, NÝ 10018

TEL: 212 691 3248 FAX: 212 633 1613

ENCLOSURE/SITE/MEPFP/INTERIOR

BID PACKAGE 3

MAY 14, 2012

SEAL & SIGNATURE

FOOD & WASTE MANAGEMENT: WILLIAM CARUSO & ASSOCIATES, INC.

SIGNAGE & WAYFINDING: RAFAEL VINOLY ARCHITECTS PC

RAFAEL VINOLY ARCHITECTS P

ON BEHALF OF

OSE PROJECT NUMBER: H27-6069-AC-3

743 GREENE STREET COLUMBIA, SC 20298


50 VANDAM STREET NEW YORK, NY 10013

ENGINEER:

PROJECT NAME:

SHEET TITLE :

KEY PLAN & NORTH SIGN

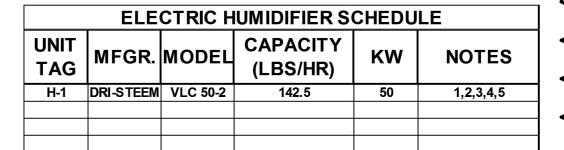

NOTES: 1. FURNISH WITH MEANS OF DISCONNECT.

- 2. FURNISH WITH SCR MODULATION.
- 3. FURNISH WITH VAV CONTROL, AIR FLOW PROVING SWITCH & DUCT HIGH LIMIT SWITCH.
- 4. FURNISH WITH FLOOR. MOUNT CONTROL PANEL ON UNIT & BACNET INTERFACE
- 5. FURNISH WITH MFGR'S INJECTION TUBES & INSULATED FLEXIBLE HOSES.
- 6. PROVIDE WITH DRAIN TEMPERING KIT. ROUTE TO NEAREST FLOOR DRAIN/SINK.


MOORE SCHOOL OF BUSINESS UNIVERSITY OF SOUTH CAROLINA BID PACKAGE 3 ENCLOSURE/SITE/MEPFP/INTERIOR ADDENDUM #003 PROJECT NO. 655.000

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/4\	2012.0	16.22		/\		
	2012.			$\overline{}$		
$\bigcirc RL$	AFΔFI	VINOL:	Υ	ΔRCH	ITECTS PC	

UNDERFLOOR AIR DISTRIBUTION DEVICE SCHEDULE REF. DWG M6104 SHEET TITLE: HVAC SCHEDIII ES

SCALE : 1" = 1'-0"

SHEET NUMBER M-SK-002

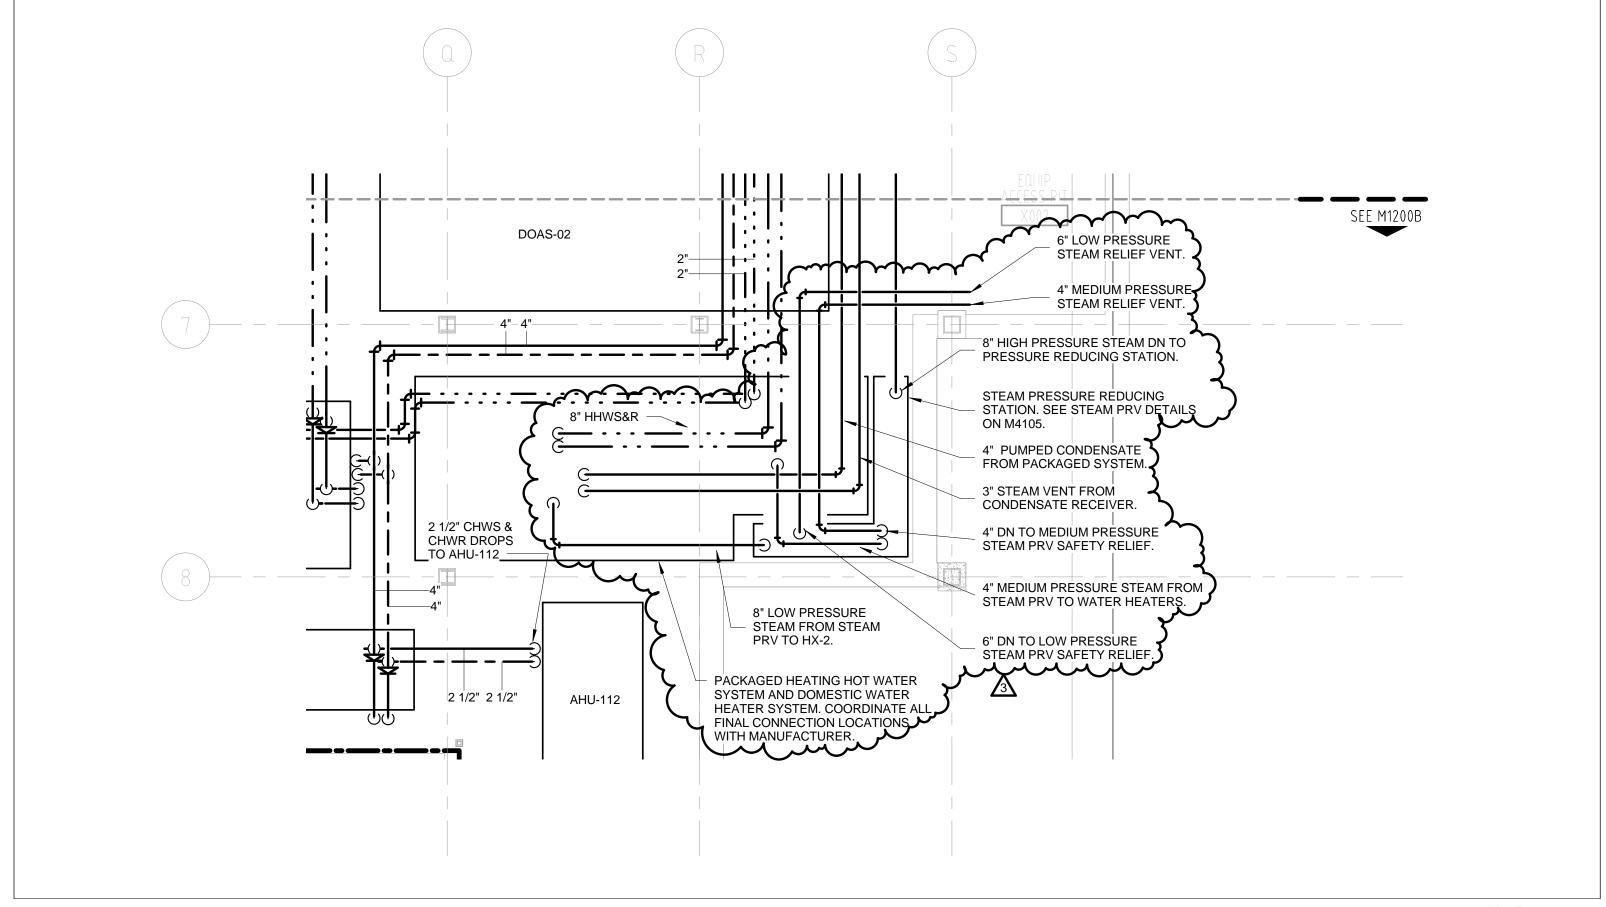


CRAFAEL VINOLY ARCHITECTS PC | SHEET TITLE:

HVAC PIPING PLAN - LEVEL 0 - ZONE A REF. DWG # M1200B

SCALE 1/8" = 1'-0"

SHEET NUMBER M-SK-003

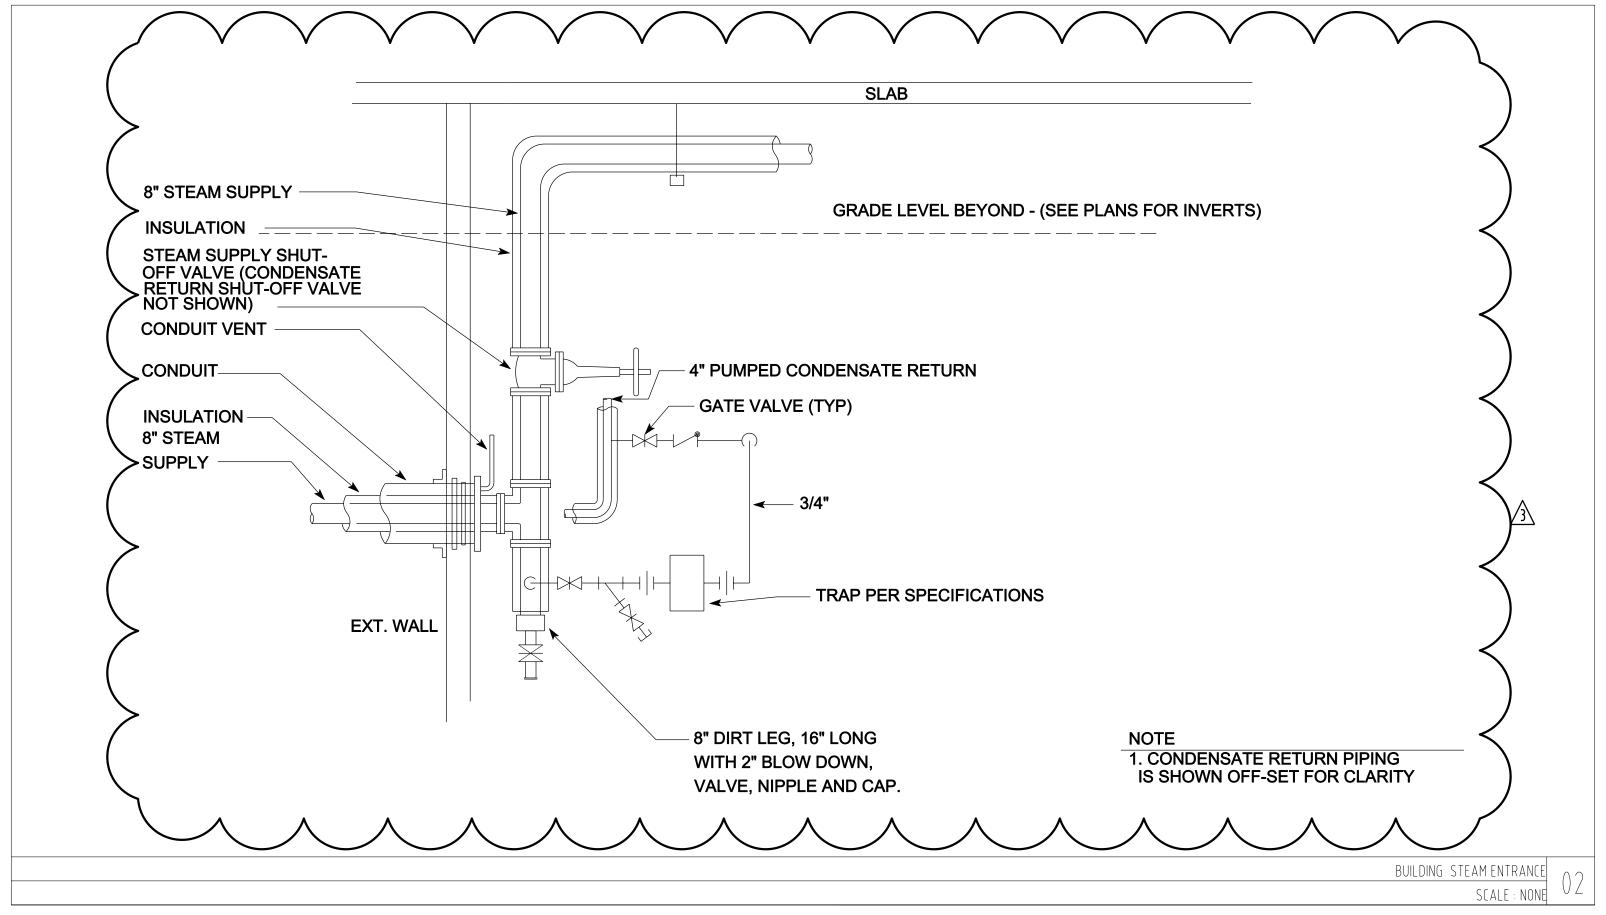

PROJECT NO. 655.000

2012.06.22


© RAFAEL VINOLY ARCHITECTS PC

BUILDING STEAM ENTRANCE REF. DWG # M4102

SHEET TITLE

SCALE : NONE

SHEET NUMBER M-SK-004

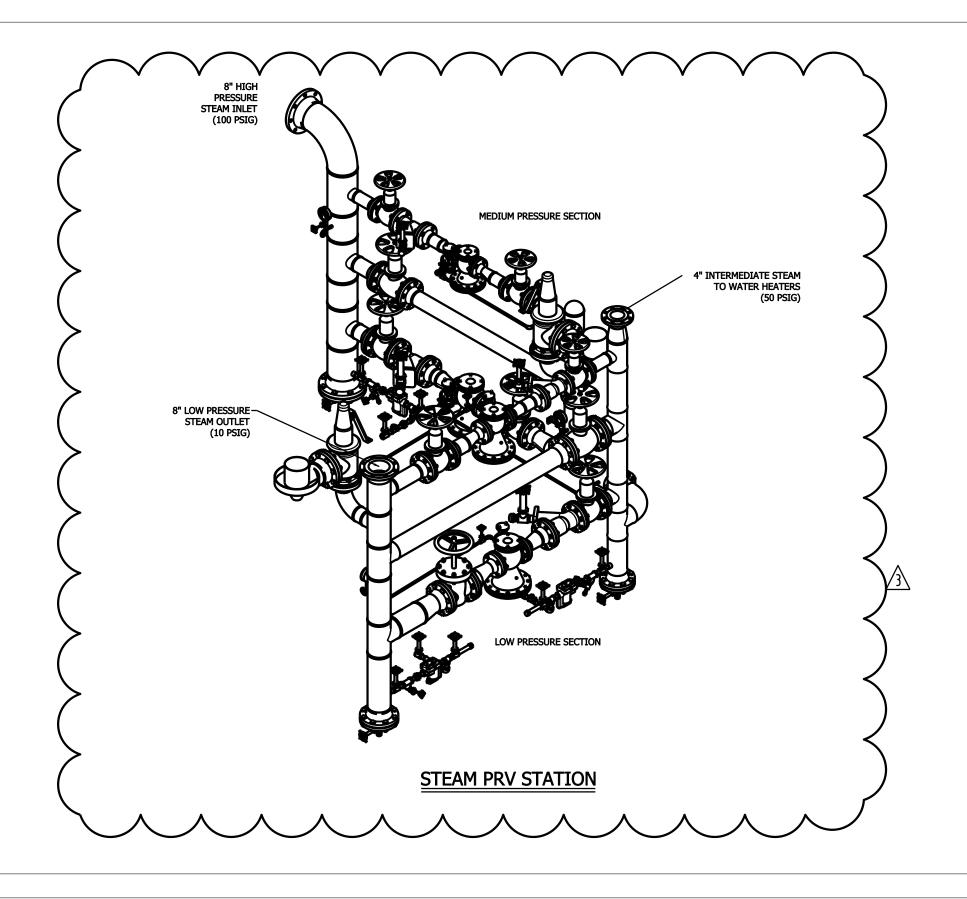

PRV STATION SCALE : NONE


MOORE SCHOOL OF BUSINESS UNIVERSITY OF SOUTH CAROLINA BID PACKAGE 3 ENCLOSURE/SITE/MEPFP/INTERIOR ADDENDUM #003

PROJECT NO. 655.000

PRV STATION - REF. DWG # M4105

SHEET TITLE :

| SCALE : | NONE

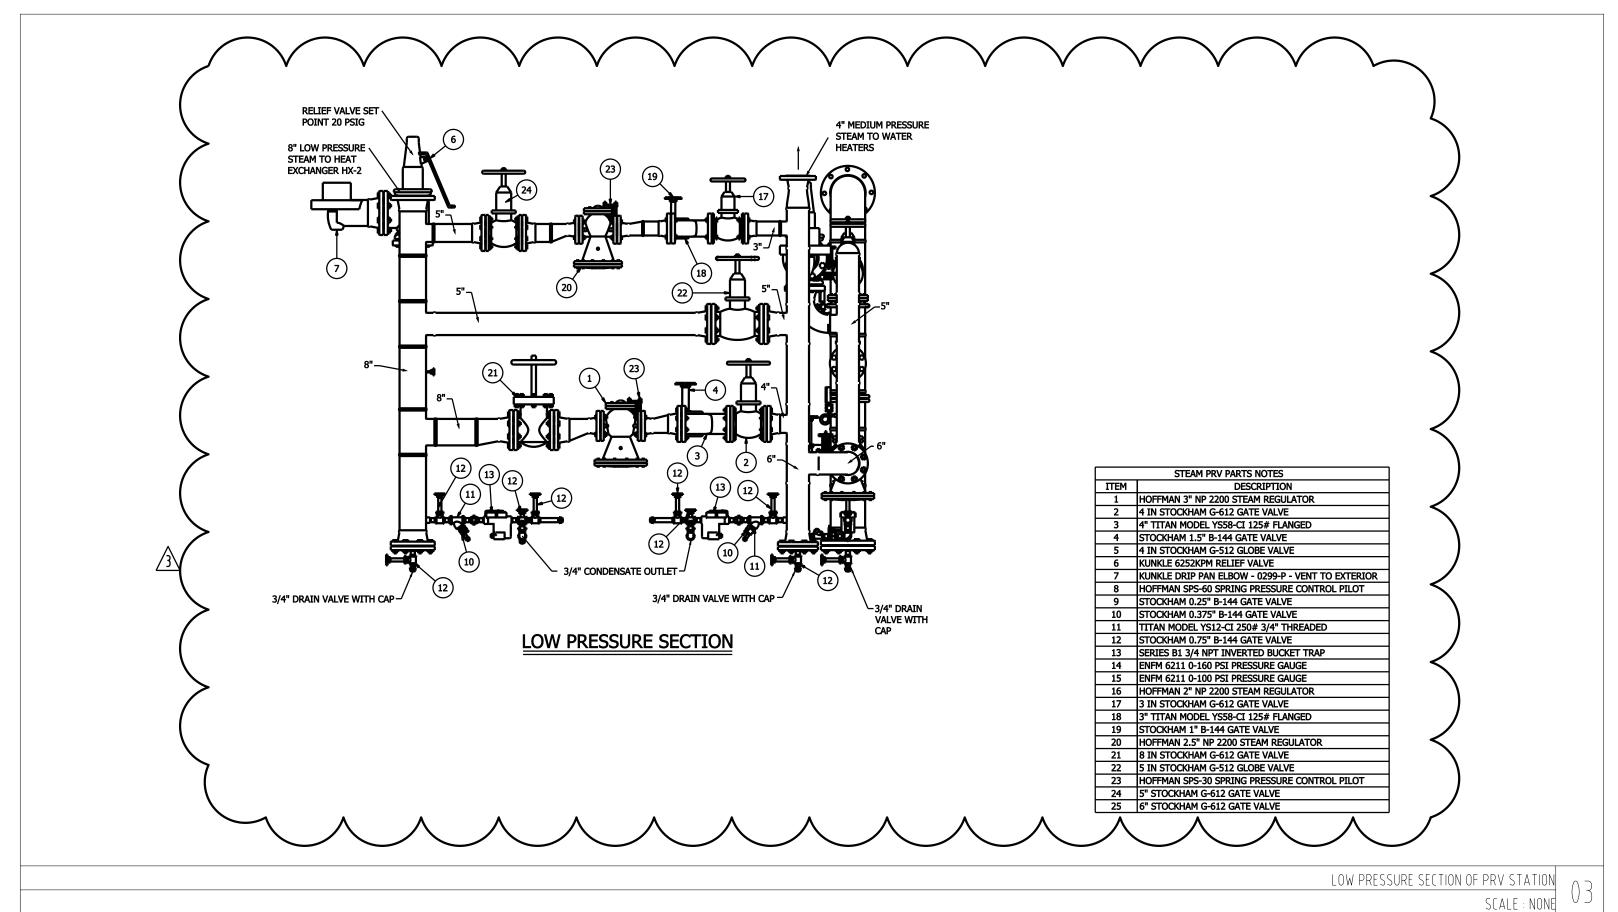

CALE.

MOORE SCHOOL OF BUSINESS UNIVERSITY OF SOUTH CAROLINA BID PACKAGE 3 ENCLOSURE/SITE/MEPFP/INTERIOR ADDENDUM #003


PROJECT NO. 655.000

 LOW PRESSURE SECTION OF PRV STATION-REF. DWG # M4105

SHEET TITLE :

SCALE : NONE

SHEET NUMBER : M-SK-006

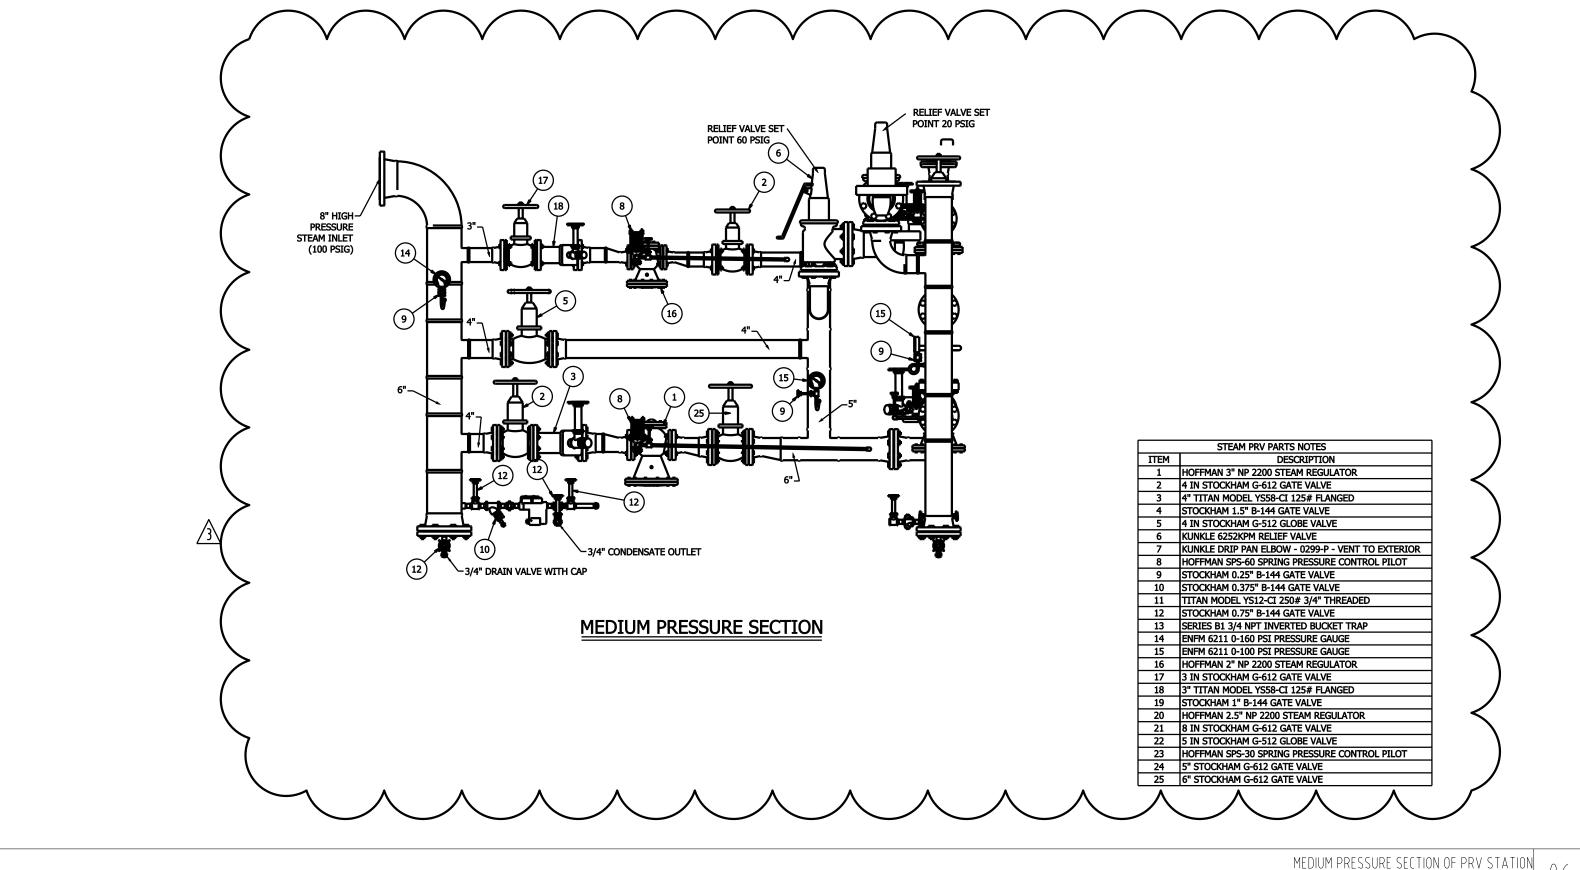

MEDIUM PRESSURE SECTION OF PRV STATION
SCALE: NONE

A. F

MOORE SCHOOL OF BUSINESS UNIVERSITY OF SOUTH CAROLINA BID PACKAGE 3 ENCLOSURE/SITE/MEPFP/INTERIOR ADDENDUM #003

PROJECT NO. 655.000


2 2012.06.22 A CHITECTS PC

_ | MEDIUM PRESSURE SECTION OF PRV STATION - | REF. DWG # M4105

SHEET TITLE :

SCALE : NONE

SHEET NUMBER : M-SK-007

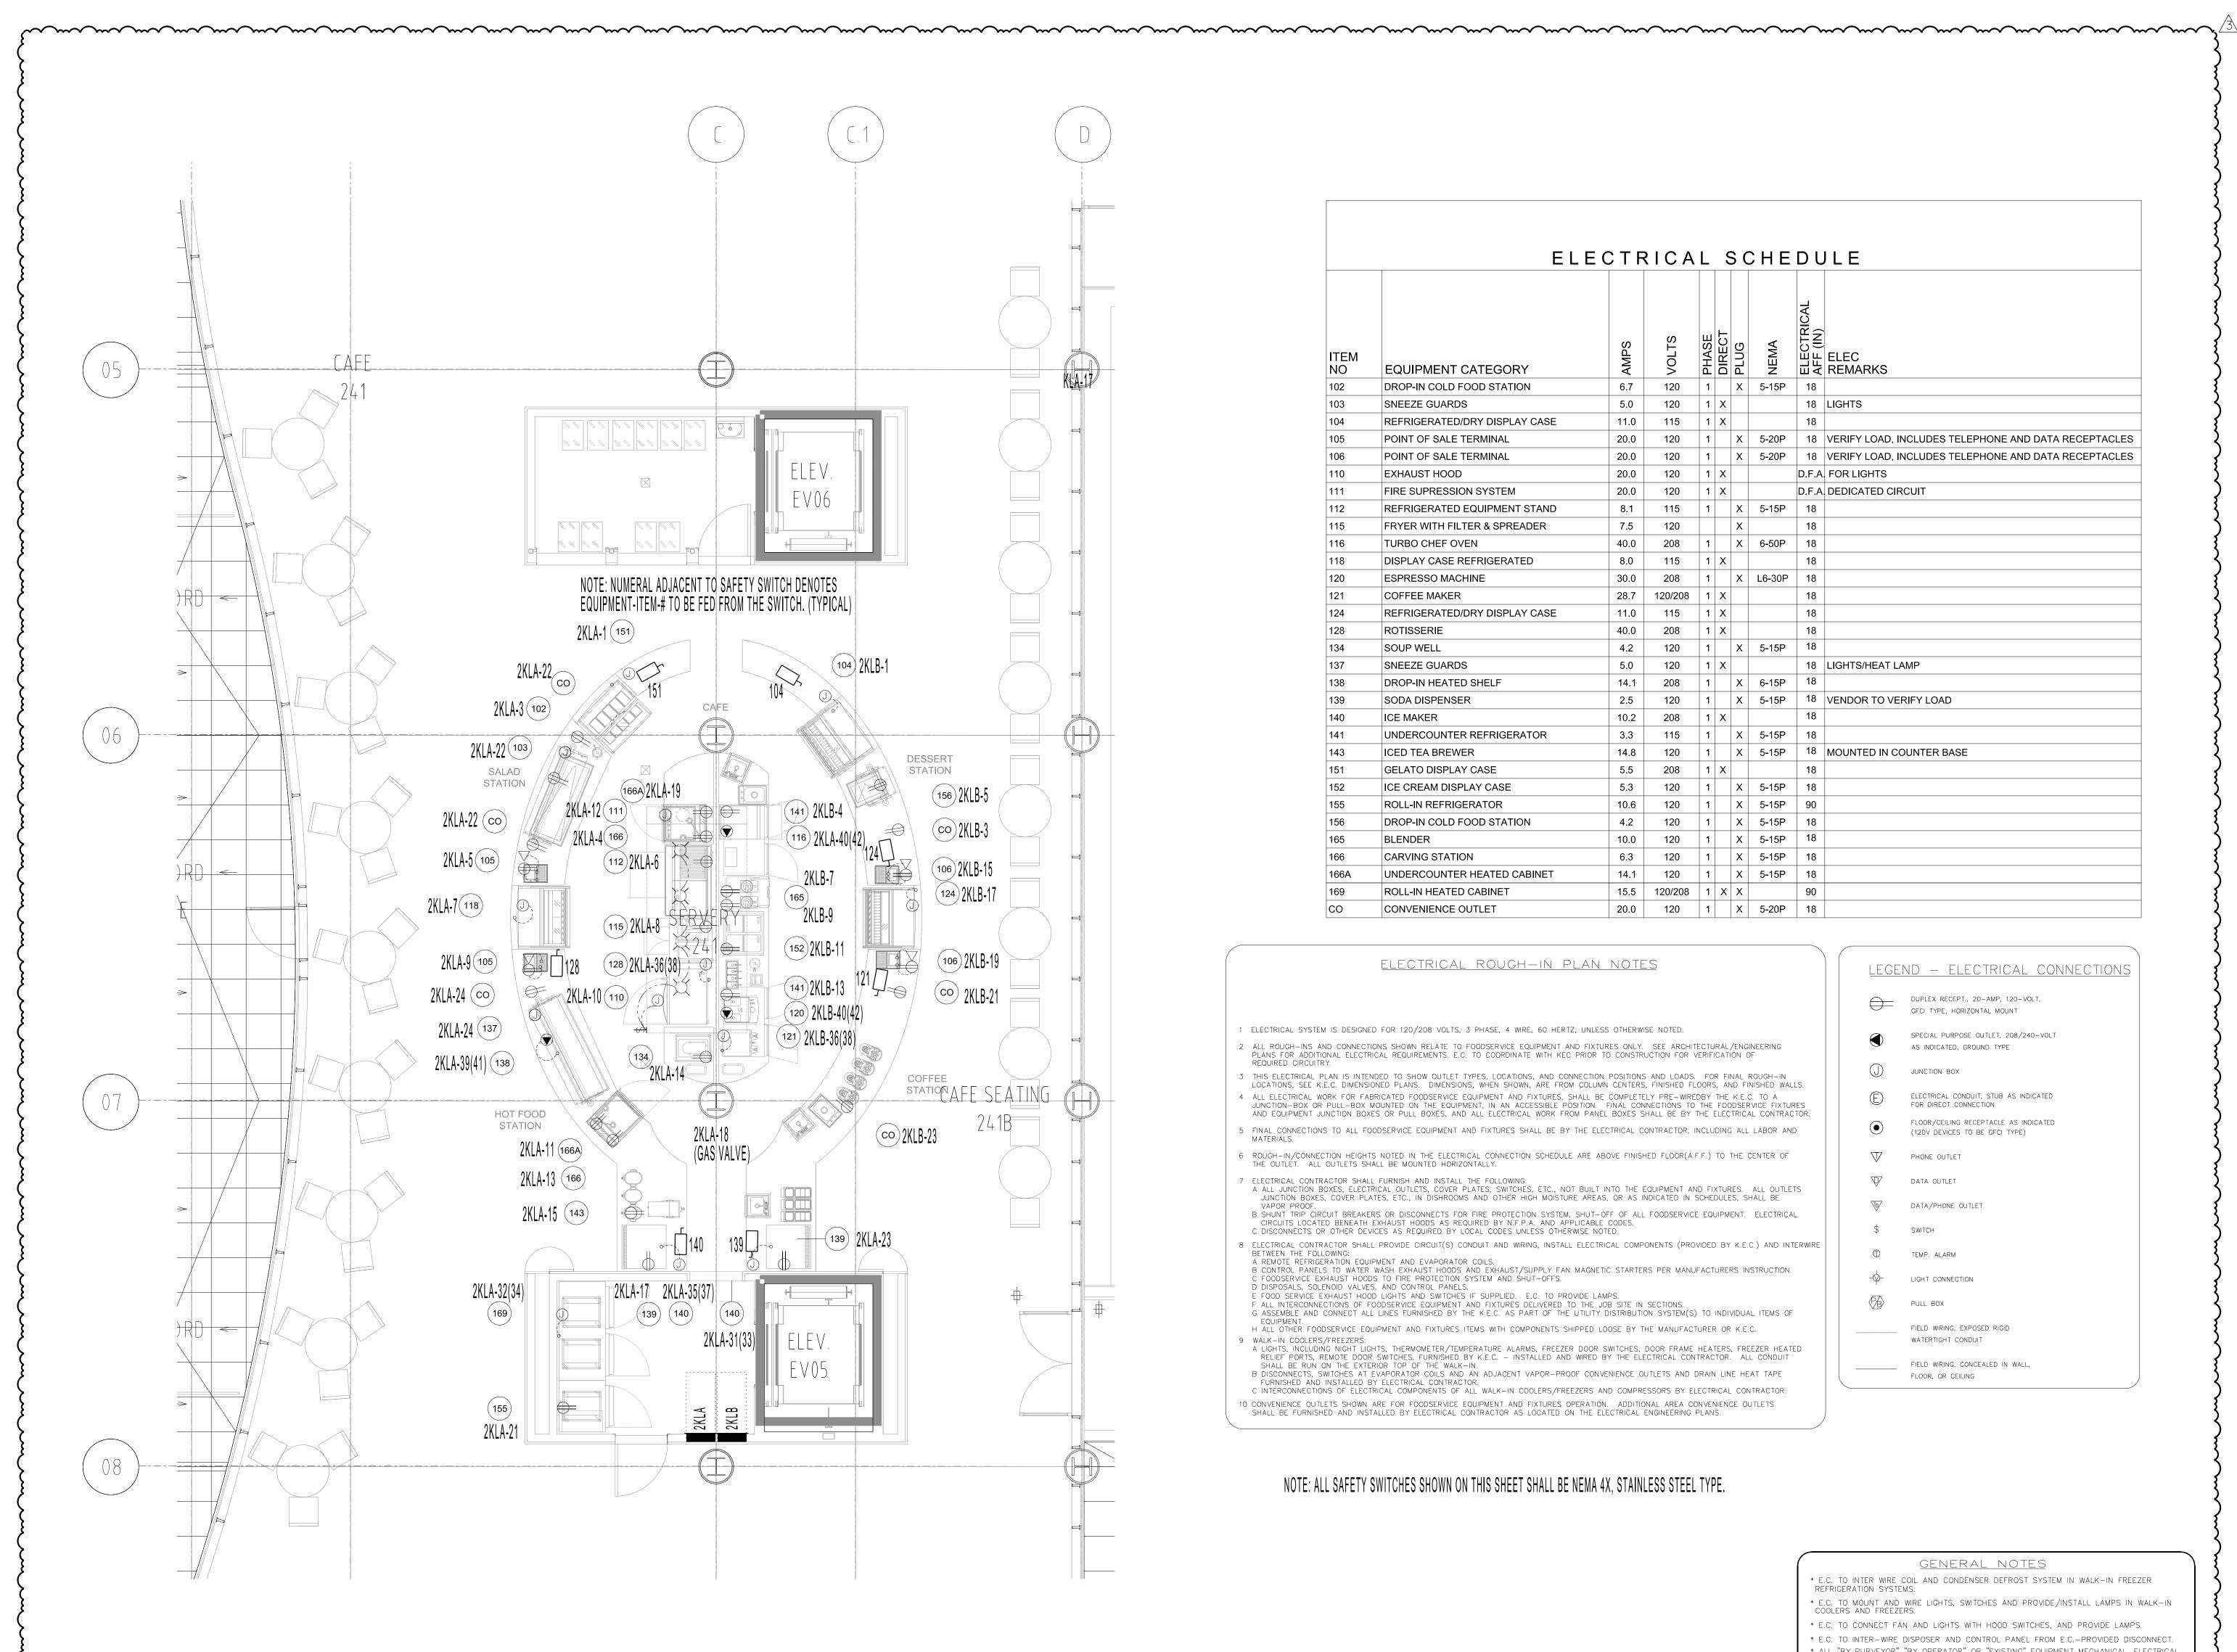

	ELE	CTF	RICA	L	\ \(\)	3 (CHE	DULE
ITEM NO	EQUIPMENT CATEGORY	AMPS	VOLTS	PHASE	DIRECT	PLUG	NEMA	AFF (IN) SHENCAL AFF (IN) ELEC REMARKS
102	DROP-IN COLD FOOD STATION	6.7	120	1		Х	5-15P	18
103	SNEEZE GUARDS	5.0	120	1	Х			18 LIGHTS
104	REFRIGERATED/DRY DISPLAY CASE	11.0	115	1	Х			18
105	POINT OF SALE TERMINAL	20.0	120	1		X	5-20P	18 VERIFY LOAD, INCLUDES TELEPHONE AND DATA RECEPTACE
106	POINT OF SALE TERMINAL	20.0	120	1		Х	5-20P	18 VERIFY LOAD, INCLUDES TELEPHONE AND DATA RECEPTACE
110	EXHAUST HOOD	20.0	120	1	Х			D.F.A. FOR LIGHTS
111	FIRE SUPRESSION SYSTEM	20.0	120	1	Х			D.F.A. DEDICATED CIRCUIT
112	REFRIGERATED EQUIPMENT STAND	8.1	115	1		Х	5-15P	18
115	FRYER WITH FILTER & SPREADER	7.5	120			Х		18
116	TURBO CHEF OVEN	40.0	208	1		Х	6-50P	18
118	DISPLAY CASE REFRIGERATED	8.0	115	1	Х			18
120	ESPRESSO MACHINE	30.0	208	1		Х	L6-30P	18
121	COFFEE MAKER	28.7	120/208	1	Х			18
124	REFRIGERATED/DRY DISPLAY CASE	11.0	115	1	Х			18
128	ROTISSERIE	40.0	208	1	Х			18
134	SOUP WELL	4.2	120	1		Х	5-15P	18
137	SNEEZE GUARDS	5.0	120	1	Х			18 LIGHTS/HEAT LAMP
138	DROP-IN HEATED SHELF	14.1	208	1		Х	6-15P	18
139	SODA DISPENSER	2.5	120	1		Х	5-15P	18 VENDOR TO VERIFY LOAD
140	ICE MAKER	10.2	208	1	Х			18
141	UNDERCOUNTER REFRIGERATOR	3.3	115	1		Х	5-15P	18
143	ICED TEA BREWER	14.8	120	1		Х	5-15P	18 MOUNTED IN COUNTER BASE
151	GELATO DISPLAY CASE	5.5	208	1	Х			18
152	ICE CREAM DISPLAY CASE	5.3	120	1		Х	5-15P	18
155	ROLL-IN REFRIGERATOR	10.6	120	1		Х	5-15P	90
156	DROP-IN COLD FOOD STATION	4.2	120	1		Х	5-15P	18
165	BLENDER	10.0	120	1		Х	5-15P	18
166	CARVING STATION	6.3	120	1		Х	5-15P	18
166A	UNDERCOUNTER HEATED CABINET	14.1	120	1		Х	5-15P	18
169	ROLL-IN HEATED CABINET	15.5	120/208	1	X	Х		90
СО	CONVENIENCE OUTLET	20.0	120	1		Х	5-20P	18

ELECTRICAL ROUGH-IN PLAN NOTES

ELECTRICAL SYSTEM IS DESIGNED FOR 120/208 VOLTS, 3 PHASE, 4 WIRE, 60 HERTZ, UNLESS OTHERWISE NOTED.

2 ALL ROUGH—INS AND CONNECTIONS SHOWN RELATE TO FOODSERVICE EQUIPMENT AND FIXTURES ONLY. SEE ARCHITECTURAL/ENGINEERING PLANS FOR ADDITIONAL ELECTRICAL REQUIREMENTS. E.C. TO COORDINATE WITH KEC PRIOR TO CONSTRUCTION FOR VERIFICATION OF REQUIRED CIRCUITRY.

3 THIS ELECTRICAL PLAN IS INTENDED TO SHOW OUTLET TYPES, LOCATIONS, AND CONNECTION POSITIONS AND LOADS. FOR FINAL ROUGH—IN LOCATIONS, SEE K.E.C. DIMENSIONED PLANS. DIMENSIONS, WHEN SHOWN, ARE FROM COLUMN CENTERS, FINISHED FLOORS, AND FINISHED WALLS. 4 ALL ELECTRICAL WORK FOR FABRICATED FOODSERVICE EQUIPMENT AND FIXTURES, SHALL BE COMPLETELY PRE-WIREDBY THE K.E.C. TO A JUNCTION-BOX OR PULL-BOX MOUNTED ON THE EQUIPMENT, IN AN ACCESSIBLE POSITION. FINAL CONNECTIONS TO THE FOODSERVICE FIXTURES AND EQUIPMENT JUNCTION BOXES OR PULL BOXES, AND ALL ELECTRICAL WORK FROM PANEL BOXES SHALL BE BY THE ELECTRICAL CONTRACTOR. 5 FINAL CONNECTIONS TO ALL FOODSERVICE EQUIPMENT AND FIXTURES SHALL BE BY THE ELECTRICAL CONTRACTOR, INCLUDING ALL LABOR AND MATERIALS.

6 ROUGH-IN/CONNECTION HEIGHTS NOTED IN THE ELECTRICAL CONNECTION SCHEDULE ARE ABOVE FINISHED FLOOR(A.F.F.) TO THE CENTER OF THE OUTLET. ALL OUTLETS SHALL BE MOUNTED HORIZONTALLY.

7 ELECTRICAL CONTRACTOR SHALL FURNISH AND INSTALL THE FOLLOWING:
A ALL JUNCTION BOXES, ELECTRICAL OUTLETS, COVER PLATES, SWITCHES, ETC., NOT BUILT INTO THE EQUIPMENT AND FIXTURES. ALL OUTLETS
JUNCTION BOXES, COVER PLATES, ETC., IN DISHROOMS AND OTHER HIGH MOISTURE AREAS, OR AS INDICATED IN SCHEDULES, SHALL BE
VAPOR PROOF. B SHUNT TRIP CIRCUIT BREAKERS OR DISCONNECTS FOR FIRE PROTECTION SYSTEM, SHUT-OFF OF ALL FOODSERVICE EQUIPMENT. ELECTRICAL CIRCUITS LOCATED BENEATH EXHAUST HOODS AS REQUIRED BY N.F.P.A. AND APPLICABLE CODES. C DISCONNECTS OR OTHER DEVICES AS REQUIRED BY LOCAL CODES UNLESS OTHERWISE NOTED.

8 ELECTRICAL CONTRACTOR SHALL PROVIDE CIRCUIT(S) CONDUIT AND WIRING, INSTALL ELECTRICAL COMPONENTS (PROVIDED BY K.E.C.) AND INTERWIRE BETWEEN THE FOLLOWING:
A REMOTE REFRIGERATION EQUIPMENT AND EVAPORATOR COILS.
B CONTROL PANELS TO WATER WASH EXHAUST HOODS AND EXHAUST/SUPPLY FAN MAGNETIC STARTERS PER MANUFACTURERS INSTRUCTION.
C FOODSERVICE EXHAUST HOODS TO FIRE PROTECTION SYSTEM AND SHUT-OFFS.
D DISPOSALS SOLENOW WALVES AND CONTROL PANELS

D DISPOSALS, SOLENOID VALVES, AND CONTROL PANELS.

E FOOD SERVICE EXHAUST HOOD LIGHTS AND SWITCHES IF SUPPLIED. E.C. TO PROVIDE LAMPS.

F ALL INTERCONNECTIONS OF FOODSERVICE EQUIPMENT AND FIXTURES DELIVERED TO THE JOB SITE IN SECTIONS.

G ASSEMBLE AND CONNECT ALL LINES FURNISHED BY THE K.E.C. AS PART OF THE UTILITY DISTRIBUTION SYSTEM(S) TO INDIVIDUAL ITEMS OF

H ALL OTHER FOODSERVICE EQUIPMENT AND FIXTURES ITEMS WITH COMPONENTS SHIPPED LOOSE BY THE MANUFACTURER OR K.E.C. 9 WALK-IN COOLERS/FREEZERS: A LIGHTS, INCLUDING NIGHT LIGHTS, THERMOMETER/TEMPERATURE ALARMS, FREEZER DOOR SWITCHES, DOOR FRAME HEATERS, FREEZER HEATED RELIEF PORTS, REMOTE DOOR SWITCHES, FURNISHED BY K.E.C. — INSTALLED AND WIRED BY THE ELECTRICAL CONTRACTOR. ALL CONDUIT

SHALL BE RUN ON THE EXTERIOR TOP OF THE WALK-IN. B DISCONNECTS, SWITCHES AT EVAPORATOR COILS AND AN ADJACENT VAPOR-PROOF CONVENIENCE OUTLETS AND DRAIN LINE HEAT TAPE FURNISHED AND INSTALLED BY ELECTRICAL CONTRACTOR. C INTERCONNECTIONS OF ELECTRICAL COMPONENTS OF ALL WALK—IN COOLERS/FREEZERS AND COMPRESSORS BY ELECTRICAL CONTRACTOR. 10 CONVENIENCE OUTLETS SHOWN ARE FOR FOODSERVICE EQUIPMENT AND FIXTURES OPERATION. ADDITIONAL AREA CONVENIENCE OUTLETS SHALL BE FURNISHED AND INSTALLED BY ELECTRICAL CONTRACTOR AS LOCATED ON THE ELECTRICAL ENGINEERING PLANS.

ELECTRICAL CONDUIT, STUB AS INDICATED FOR DIRECT CONNECTION FLOOR/CEILING RECEPTACLE AS INDICATED (120V DEVICES TO BE GFCI TYPE) PHONE OUTLET DATA/PHONE OUTLET SWITCH TEMP. ALARM LIGHT CONNECTION FIELD WIRING, EXPOSED RIGID

<u>LEGEND - ELECTRICAL CONNECTIONS</u>

SPECIAL PURPOSE OUTLET, 208/240-VOLT

DUPLEX RECEPT., 20-AMP, 120-VOLT, GFCI TYPE, HORIZONTAL MOUNT

AS INDICATED, GROUND TYPE

WATERTIGHT CONDUIT

FIELD WIRING, CONCEALED IN WALL,

NOTE: ALL SAFETY SWITCHES SHOWN ON THIS SHEET SHALL BE NEMA 4X, STAINLESS STEEL TYPE.

GENERAL NOTES * E.C. TO INTER WIRE COIL AND CONDENSER DEFROST SYSTEM IN WALK-IN FREEZER REFRIGERATION SYSTEMS. * E.C. TO MOUNT AND WIRE LIGHTS, SWITCHES AND PROVIDE/INSTALL LAMPS IN WALK—IN COOLERS AND FREEZERS. * E.C. TO CONNECT FAN AND LIGHTS WITH HOOD SWITCHES, AND PROVIDE LAMPS. * E.C. TO INTER-WIRE DISPOSER AND CONTROL PANEL FROM E.C.-PROVIDED DISCONNECT. AND PLUMBING INFORMATION SHOULD BE VERIFIED PRIOR TO CONSTRUCTION. * P.C. TO FURNISH AND INSTALL BRASS BALL VALVES/STOPS IN PIPE

* ROUGH-IN DIMENSIONS AND DETAILS ARE FOR REFERENCE ONLY - REFER TO KEC SUBMITTALS FOR FINAL ROUGH-IN DETAILS AND LOCATIONS.

SIZE INDICATED TO ALL H/C CONNECTIONS ON ALL FS EQUIPMENT SHOWN.

CAFE AND SERVERY ELECTRICAL ROUGH-IN PLAN

Scale: 1/4" = 1'-0"

USC CAMPUS PLANNING & CONSTRUCTION

PROJECT NAME: UNIVERSITY OF SOUTH CAROLINA DARLA MOORE SCHOOL OF BUSINESS CONSTRUCTION OSE PROJECT NUMBER: H27-6069-AC-3

USC BUSINESS PARTNERSHIP FOUNDATION

ON BEHALF OF

743 GREENE STREET COLUMBIA, SC 20298 TEL 803 777 4022 FAX 803 777 0484

RAFAEL VINOLY ARCHITECTS PO 50 VANDAM STREET NEW YORK, NY 10013 TEL: 212 924 5060 FAX: 212 924 5858

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BP BARBER & ASSOCIATES, INC. 101 RESEARCH DRIVE COLUMBIA, SC 29202-1116 TEL: 803 429 4028 FAX:

BUILDING CODE: HUGHES ASSOCIATES 3610 COMMERCE DRIVE, SUITE 817 BALTIMORE, MD 21227-1652 TEL: 410 737 8677 FAX: 410 737 8688

LIGHTING DESIGNER ONE LUX STUDIO, LLC 39 WEST 13TH, STREET NEW YORK, NY 10011 TEL: 212 201 5792 FAX: 212 615 3700 FOOD & WASTE MANAGEMENT: WILLIAM CARUSO & ASSOCIATES, INC.

8055 EAST TUFTS AVE, SUITE 1320 DENVER, CO 80237 TEL: 303 649 1600 FAX: 303 649 1660 SIGNAGE & WAYFINDING: RAFAEL VINOLY ARCHITECTS PC 50 VANDAM STREET

TEL: 212 924 5060 FAX: 212 924 5858 SPECIFICATIONS: ROBERT SCHWARTZ & ASSOCIATES 589 8TH. AVE., 17TH. FLOOR NEW YORK, NY 10018

TEL: 212 691 3248 FAX: 212 633 1613

NEW YORK NY 10013

BID PACKAGE 3 ENCLOSURE/SITE/MEPFP/INTERIOR MAY 14, 2012

SEAL & SIGNATURE

ISSUE ISSUE ISSUE ISSUE ISSUE NO. DATE NO. DATE NO. DATE


KEY PLAN & NORTH SIGN



KITCHEN POWER PLAN

PANELBOARD												'2k	(LA	4'	!	SERV	ICE:20	8/120 °	VOLTS	,30;4V
CONDUCTORS (AWG OR MCM) (AWG O			LOAD DESCRIPTION	C.B. AMP	KVA LOAD	CCT #		DOUBLE NEUTRAL CCT			C.B. AMP	LOAD DESCRIPTION			NDUC FOR MCN N	CTORS	S IG	CONDUIT SIZE (INCH)		
	12				151- GELATO DISPLAY CASE	20	1.30	1			2		20	SPARE						
3/4	12	12	12	NA	102-DROP-IN COLD FOOD STATION	20	0.80	3			4		_	166-CARVING STATION	1	12	12	12	NA	3/4
	12				105-POS STATION	20	1.00	5			6		20	112- REFRIGERATED STAND	7	12				1
	12				118-REFRIGERATED DISPLAY CASE	20	1.00	7			8		20	115-FRYER RECEPTACLE	1	12				
3/4	12	12	12	NA	105-POS STATION	20	1.00	9			10		20	110-HOOD LIGHTS	1	12	12	12	NA	3/4
	12				166A-HEATED CABINET RECEPTACLE	20	1.70	11			12		20	111-FIRE SUPRESSION SYSTEM	1	12	12	12	NA	3/4
	12				166-CARVING STATION	20	0.75	13			14		20	134-SOUP WELL	1	12	12	12	NA	3/4
3/4	12	12	12	NA	143-ICE TEA BREWER	20	1.78	15			16		20	SPARE						
	12				139-SODA DISPENSER	20	0.30	17			18		20	GAS VALVE	<u>A</u>	12	12	12	NA	3/4
3/4	12	12	12	NA	166A-HEATED CABINET RECEPTACLE	20	1.70	19			20		20	SHUNT TRIP CB POWER	<u>A</u>	12	12	12	NA	3/4
3/4	12	12	12	NA	155-ROLL-IN REFRIGERATOR	20	1.30	21			22		20	103 & CONVENIENCE RECEPTACLES						
	12				139-SODA DISPENSER	20	0.30	23		$\overline{}$	24			137 & CONVENIENCE RECEPTACLES						
	10							25			26			SPARE						
3/4	10	NA	10	NA	HOOD MUA FAN	30		27			28		20	SPARE						
	10							29		$\overline{}$	30		20	SPARE						
3/4	12		12	NA	140-ICE MAKER	20	1.10	31	-1		32		20	169-ROLL-IN HEATED CABINET	T.	12	12	12	NA	3/4
	12					20	1.10	33			34				<u></u>	12				
3/4	12	NA	12	NA	140-ICE MAKER	20	1.10	35		1—	36		50	128-ROTISSERIE		6	NA	10	NA	1
	12						1.10	37		^_	38					6				
3/4	12	NA	12	NA	138-DROP-IN HEATED SHELF	20	1.47	39	_1		40		50	116-TURBO CHEF OVEN	П	6	NA	10	NA	1
	12						1.47	41			42					6				
225A MINIMUM BUS RATING 200A MAIN C.B. RATING 10K MINIMUM AIC RATING 2. PROVIDE PAD-LOCKABLE HASPS FOR ALL BRANCH CIRCUIT BREAKERS, SO THAT CB CAN BE PADLOCKED IN THE OFF POSITION PER NEC-422.									BE		GROUND BUS SURFACE MOUNTED NEMA 1	FN			THRU	LUGS				

PROJECT NO. 655.000

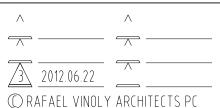

PANELBOARD SCHEDULES-LEVEL 2 REF. DWG # E3002

SHEET TITLE :

SCALE : NOT TO SCALE

	PANELBOARD												(LE	3'	SER'	VICE:2	08/120	VOLTS	3,30;4W
SIZE (INCH)		(AMAD LOAD # CA CD CO		CCT #	KVA LOAD	C.B. AMP	C.B. LOAD DESCRIPTION		CONDUCTORS (AWG OR MCM) Ø N G IG										
	12				104-REFRIGERATED DISPLAY CA	20		1	$\overline{}$	1-	2		20	KITCHEN SUPPLY FAN	12	12	12	NA	3/4
/4	12	12	12	NA	CONVENIENCE RECEPTACLES	20		3			4		20	141-REFRIGERATOR	12	12	12	NA	3/4
	12				156-DROP-IN COLD FOOD STATION	20		5			6		20	SPARE					
	12				165-BLENDER	20		7			8		20	SPARE					
/4	12	12	12	NA	165-BLENDER	20		9			10		20	SPARE					
	12				152-ICE CREAM DISPLAY CASE	20		11			12		20	SPARE					
	12				141-REFRIGERATOR	20		13	$\overline{}$		14		20	SPARE					
/4	12	12	12	NA	106-POS STATION	20		15			16		20	SPARE					
	12				124-REFRIGERATED DISPLAY CASE	20		17	-	\rightarrow	18		20	SPARE					
	12	12	12	NA	106-POS STATION	20		19	$\overline{}$		20		20	SPARE					
/4	12	12	12	NA	CONVENIENCE RECEPTACLES	20		21			22		20	SPARE					
	12				CONVENIENCE RECEPTACLES	20		23	-		24		20	SPARE					
					SPARE	20		25	$\overline{}$		26		20	SPARE					
					SPARE	20		27			28		20	SPARE					
								29	-1	-	30		20	SPARE					
					SPARE	30		31	-1		32		20	SPARE					
								33			34		20	SPARE					
					SPARE	20		35	-1	<u> </u>	36		20	121-COFFEE MAKER	8	8	10	NA	3/4
								37			38				8				
					SPARE	20		39			40		30	120-ESPRESSO MACHINE	10	NA	10	NA	3/4
								41			42				10				
225A MINIMUM BUS RATING 200A MAIN C.B. RATING 10K MINIMUM AIC RATING 10K MINIMUM AIC RATING 205A MINIMUM AIC RATING 206A PANELBOARD KEYNOTES: 1. PROVIDE SHUNT TRIP MAIN CB CONTROLLED BY THE FIRE ALARM SYSTEM. 2. PROVIDE PAD-LOCKABLE HASPS FOR ALL BRANCH CIRCUIT BREAKERS, SO THAT CB CAN PADLOCKED IN THE OFF POSITION PER NEC-422.									BE	■ GROUND BUS ■ FEED THRU LUGS ■ SURFACE MOUNTED NEMA 1 ENCLOSURE									

^ ^ ^ ^ ^ ^ \[\frac{\sqrt{2012.06.22}}{\sqrt{2012.06.22}} \]
\[\text{RAFAEL VINOLY ARCHITECTS PC} \] PANELBOARD SCHEDULES-LEVEL 2 REF. DWG # E3002

SHEET TITLE :

SCALE : NOT TO SCALE